

OWNER:

BRUCE TITUS AUTOMOTIVE GROUP 6221 TACOMA MALL BLVD **TACOMA**, WA 98409

ARCHITECT:

BOE ARCHITECTS 1130 BROADWAY, SUITE 207 TACOMA, WA 98402 PH: 253.383.7762 CONTACT: DAVID BOE, AIA

CIVIL ENGINEER:

HENDRICKSON ENGINEERING PLLC 6909 FORD DR NW GIG HARBOR, WA 98335 PH: 253.514.2413 CONTACT: DAN HENDRICKSON, P.E. EMAIL: dan@hendricksoncc.com

GEOTECH:

ASSOCIATED EARTH SCIENCES INC. 911 5TH AVE KIRKLAND, WA 98033 PH: 425.827.7701 CONTACT: JAMES M. BRISBINE, PE, LG, LEG

SURVEYOR:

APEX ENGINEERING PLLC 2601 SOUTH 35TH, SUITE 200 **TACOMA, WA 98409** PH: 253.473.4494 CONTACT: TIMOTHY MCDANIEL, PLS

BASIS OF BEARING

HELD SOUTH 88°42'01" EAST BETWEEN CITY OF TACOMA

CONTROL MONUMENTS #1220 AND #1033

HORIZONTAL DATUM

WASHINGTON STATE PLAN COORDINATE SYSTEM, SOUTH ZONE (NAD 83/91)

BASED ON TIES CITY OFTACOMA MONUMENTS #34, 1033, 1219 AND 1220.

COT MONUMENT #1220

N 695117.01 E 1147556.43

FOUND 3" BRASS DISK W/PUNCH ON SURFACE AT INTX. OF

S. 38TH ST. AND UNION AVE.

VERTICAL DATUM

CITY OF TACOMA NGVD 29

BENCHMARK 3760

DESC "X" ON SE BOLT OF STREET LIGHT POLE AT THE SE CORNER OF THE INTERSECTION OF S 38TH STREET AND SOUTH TACOMA WAY. ELEV: 263.28'


LEGAL DESCRIPTION

Section 13 Township 20 Range 02 Quarter 14 : BEG AT A PT ON WLY LI SO TAC WAY 296.02 FT N OF E & W C/L OF SEC TH NELY ALG WLY LI SO TAC WAY 100 FT WHICH IS 392.04 FT N OF E & W C/L OF SEC TH W PAR WITH SD C/L 442 FT TO ELY LI N P R/W TH SWLY ALG ELY LI SD R/W TO PT 296.02 FT N OF C/L OF SEC TH E 450 FT TO BEG BEING TR OF UNREC PLAT




HENDRICKSON ENGINEERING

6909 FORD DR NW, GIG HARBOR, WA 98335 TEL: 253.514.2413

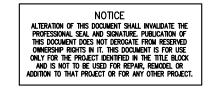







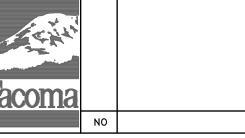

REVISION

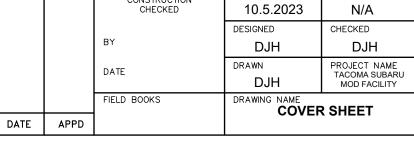



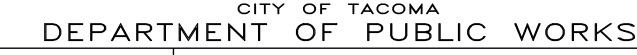

0220131004

CITY OF TACOMA ENVIRONMENTAL SERVICES

TACOMA PUBLIC UTILITIES

TACOMA PUBLIC UTILITIES

3812 SOUTH TACOMA WY

TACOMA. WA 98409

44,200 SF (1.015 AC)

SITE: CITY OF TACOMA

ROW: CITY OF TACOMA

M1-STGPD ST-M/IC- LIGHT

MANUFACTURING/INDUSTRIAL

TACOMA SUBARU MOD FACILITY

3812 SOUTH TACOMA WAY, TACOMA, WA 98409 SITE DEVELOPMENT PERMIT SET


SDEV23-0202

C_{0.1}

1 of 12

SITE AND BUILDING DIVISION

DATE: October 5, 2023 FILENAME: C:\Users\dhend\Hendrickson Const Co Dropbox\Daniel Hendrickson\Hendrickson Engineering\Projects\2022\2220033 (Tacoma Subaru Addition)\CAD\2220033-SH-COVR.dwg

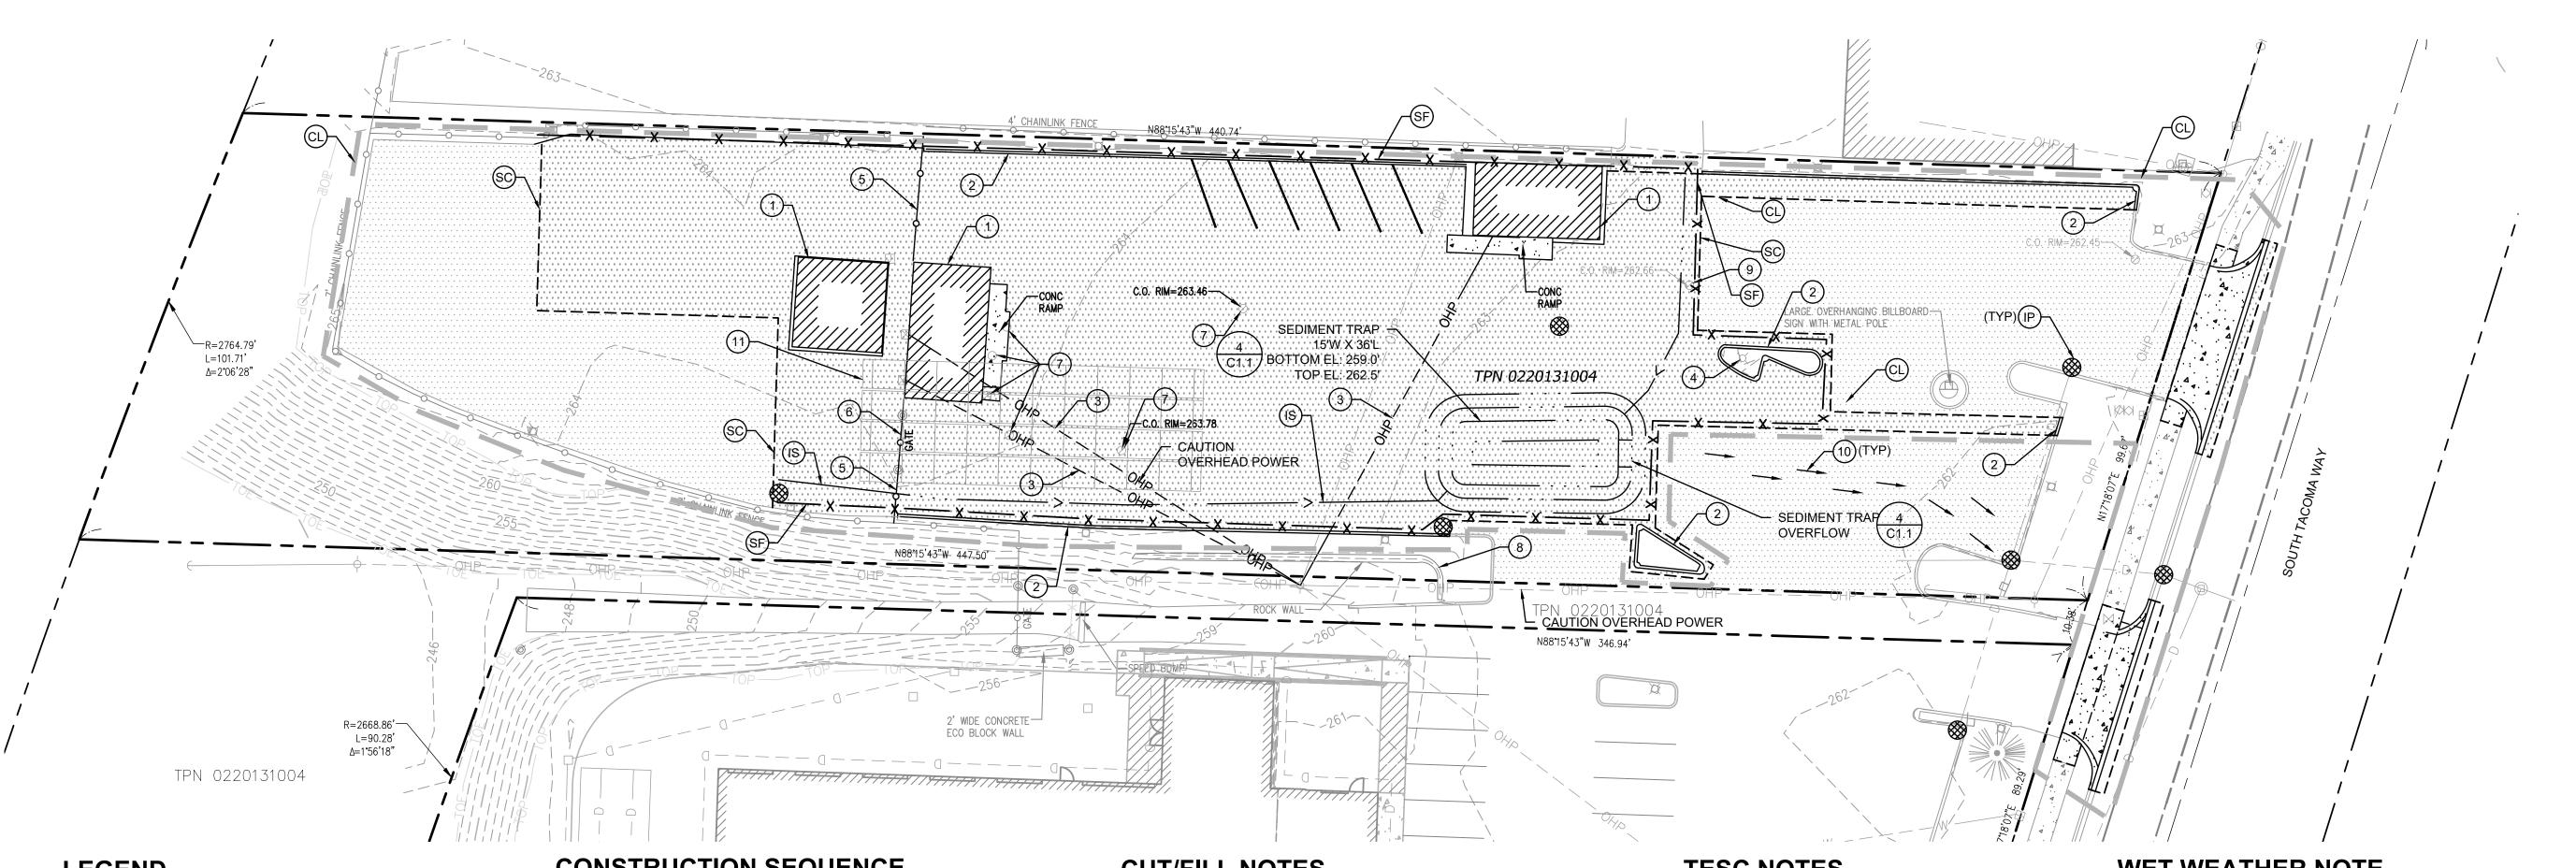

LEGEND

- (SC) NEAT SAWCUT LINE
- (SF) FILTER FABRIC FENCE
- (CL) CLEARING LIMITS
- (IP) INLET SEDIMENT PROTECTION
- (IS) INTERCEPTOR SWALE

EXISTING PAVEMENT TO REMAIN

EXISTING CONCRETE REMOVAL

EXISTING CONCRETE TO REMAIN

KEY NOTES

- 1 REMOVE EXISTING BUILDING AND ALL ASSOCIATED APPURTENANCES.
- 2 REMOVE EXISTING CURB
- 3 EXISTING OVERHEAD POWER LINES TO BE REMOVED BY TACOMA POWER OR LICENSED PURVEYOR.
- REMOVED EXISTING LIGHT POLE TO BE RELOCATED.
- 5 REMOVE EXISTING FENCE
- 6 REMOVE EXISTING GATE
- 7 REMOVE EXISTING UTILITY AND ASSOCIATED APPURTENANCES TO MAXIMUM EXTENT NEEDED FOR CONSTRUCTION
- REMOVE PORTION OF EXISTING ROCK WALL TO BE REPLACED 8 WITH CONCRETE STAIRS AND RETAINING STRUCTURES. SEE SHEET C2.0
- 9 PROTECT EXISTING UTILITY TO REMAIN
- SEDIMENT TRAP OVERFLOW RUNOFF FLOW PATH. RUNOFF (10) SHALL DISCHARGE INTO COT STOMRWATER SYSTEM. INLET PROTECTION TO BE PROVIDED AND MAINTAINED AT ALL TIME.
- PROPOSED LOCATION OF THE INFITRATION FACILITY. THIS FACILITY SHALL BE PROTECTED ONSITE USING HIGH VISIBILITY ORANGE FENCING. THE FENCING SHALL BE LOCATED AROUND FACILITY IS COMPLETED. HEAVY MACHINERY SHALL NOT BE
- THE PERIMETER OF THE FACILITY UNTIL CONSTRUCTION OF THE PERMITTED TO DRIVE IN THIS LOCATION DURING THE DURATION OF CONSTRUCTION.

CONSTRUCTION SEQUENCE

- ARRANGE AND ATTEND A PRE-CONSTRUCTION MEETING WITH CITY OF TACOMA.
- STAKE / FLAG CLEARING AND CONSTRUCTION LIMITS.
- CONSTRUCT ALL TEMPORARY EROSION CONTROL BMP'S ACCORDING TO THE TESC PLAN. INSTALL INLET SEDIMENT PROTECTION EXISTING CATCH BASINS. INSTALL CONSTRUCTION ENTRANCE AS NEEDED.
- **INSPECTION NUMBER 1. EROSION CONTROL** DEMOLISH EXISTING SITE FEATURES.
- MAINTAIN EROSION CONTROL MEASURES IN ACCORDANCE TO CITY OF TACOMA STANDARDS AND MANUFACTURER'S RECOMMENDATIONS. INSPECTION NUMBER 2. COMPLETION OF DEMOLITION AND CLEARING
- ROUGH GRADE SITE 10. CONSTRUCT SANITARY, STORM, AND WATER SYSTEMS AND INSTALL INLET SEDIMENT PROTECTION TO NEW CATCH BASINS.SANITARY SEWER AND WATER ARE UNDER SEPARATE PERMITS AND COVER.
- 11. APPLY EROSION CONTROL MULCH AND SEEDING, STRAW MULCH OR EQUAL TO AREAS THAT WILL NOT BE BROUGHT TO FINAL GRADE OR PERMANENTLY VEGETATED WITHIN 7 DAYS OF EXPOSURE. DURING THE DRY SEASON, AND 2 DAYS OF EXPOSURE DURING THE WET SEASON (OCTOBER 1 - APRIL 30).
- 12. RELOCATE EROSION CONTROL MEASURES OR INSTALL NEW MEASURES SO THAT AS THE SITE CONDITIONS CHANGE, THE EROSION AND SEDIMENT CONTROL IS ALWAYS IN ACCORDANCE TO THE CITY SWPPP MINIMUM
- REQUIREMENTS 13. FINAL GRADE SITE AND INSTALL FINAL SURFACE TREATMENTS. ENSURE THAT SURFACE WATER IS POSITIVELY DIRECTED TOWARD PROPOSED STORM COLLECTION FACILITIES.
- 14. INSPECTION NUMBER 3. COMPLETION OF EXCAVATION, FILL AND
- EARTHWORK. 15. FINE GRADE PAVED AREA, POUR CURB & GUTTERS, AND PAVE ROADS.
- 16. REMOVE REMAINING TEMPORARY EROSION CONTROL ITEMS ONCE SITE HAD BEEN STABILIZED AND UPON APPROVAL FROM PIERCE COUNTY.
- 17. COMPLETE FINAL LANDSCAPING. 18. INSPECTION NUMBER 4. COMPLETION OF PROJECT.

DEMOLITION GENERAL NOTES

- CONTRACTOR IS RESPONSIBLE FOR ENSURING THAT ALL UTILITIES HAVE BEEN DISCONNECTED PRIOR TO COMMENCING DEMOLITION. REFER TO ELECTRICAL DRAWINGS FOR SITE ELECTRICAL
- DEMOLITION/RELOCATION.
- SIDE SEWER CONNECTIONS SHALL BE MAINTAINED. CONTRACTOR SHALL MINIMIZE DUST GENERATION ONSITE BY SPRINKLING THE SITE WITH WATER UNTIL A SURFACE IS WET. SEE BMP C140.
- REFER TO SWPPP FOR ADDITIONAL INFORMATION REGARDING EROSION CONTROL MEASURES. CONTRACTOR SHALL STAGE DEMOLITION AND CONSTRUCTION IN SUCH MANNER AS TO ALWAYS MAINTAIN A ROUTE FOR THE CONVEYANCE OF

STORMWATER FROM THE EXISTING SITE AND AREA UPSTREAM OF THE

CONSTRUCTION AREA. INSTALL CONSTRUCTION FENCING TO SECURE SITE.

CUT/FILL NOTES

CUT SLOPES SLOPES SHALL NOT BE STEEPER THAN 2 HORIZONTAL TO 1 VERTICAL, OR AS RECOMENDED BY A SOILS ENGINEER.

10 FEET

THE CATCH POINT OF THE TOP OF THE SLOPE SHALL BE SET BACK FROM THE SITE BOUNDARY LINE IN ACCORDANCE WITH THE FOLLOWING TABLE, UNLESS A RETAINING WALL IS DESIGNED BY THE ENGINEER AND CONSTRUCTED FOR THE PROJECT.

CUT DEPTH SET BACK DISTANCE **UNDER 5 FEET** 2 FEET 5 - 20 FEET

FILL STANDARDS FILL LOCATION

OVER 20 FEET

SLOPES SHALL NOT BE STEEPER THAN SOILS ENGINEER RECOMMENDATIONS. FILL SITES MUST BE APPROVED BY THE ENGINEER AS SUITABLE LOCATIONS FOR THE PROPOSED FILL.

PREPARATION OF GROUND

THE GROUND SURFACE FOR FILLS OVER FIVE FEET IN HEIGHT SHALL BE PREPARED BY REMOVING VEGETATION, NONCOMPLIANT FILL, TOPSOIL, AND OTHER UNSUITABLE MATERIALS; SCARIFYING TO PROVIDE A BOND WITH THE NEW FILL; AND, WHERE EXISTING SLOPES ARE STEEPER THAN 5 HORIZONTAL TO 1 VERTICAL, BY BENCHING INTO COMPETENT MATERIAL AS DETERMINED BY THE ENGINEER. THE BENCH UNDER THE TOE OF A FILL ON A SLOPE STEEPER THAN 5 HORIZONTAL TO 1 VERTICAL SHALL BE AT LEAST 10 FEET WIDE. OR AS RECOMMENDED BY A SOILS ENGINEER.

SETBACK FROM PROPERTY LINES

THE TOE OR CATCH POINT OF FILL SLOPES SHALL BE SET BACK FROM THE SITE BOUNDARY LINE IN ACCORDANCE WITH THE FOLLOWING TABLE, UNLESS A RETAINING WALL IS DESIGNED BY THE ENGINEER AND CONSTRUCTED FOR THE PROJECT.

SET BACK DISTANCE FILL DEPTH **UNDER 5 FEET** 2 FEET HEIGHT/2 5 - 40 FEET **OVER 40 FEET** 20 FEET

TOPOGRAPHIC NOTE

THE EXISTING CULTURAL AND TOPOGRAPHIC DATA SHOWN ON THESE DRAWINGS HAS BEEN PREPARED, IN PART, BASED UPON INFORMATION FURNISHED BY OTHERS. WHILE THIS INFORMATION IS BELIEVED TO BE RELIABLE, HENDRICKSON ENGINEERING PLLC CANNOT ENSURE ACCURACY AND THUS IS NOT RESPONSIBLE FOR THE ACCURACY OF THAT INFORMATION OR FOR ANY ERRORS OR OMISSIONS WHICH MAY HAVE BEEN INCORPORATED INTO THESE DRAWINGS AS A RESULT.

TESC NOTES

- PROVIDE TEMPORARY EROSION CONTROL MEASURES AS SHOWN ON PLANS. CONTRACTOR IS RESPONSIBLE FOR MAINTAINING AND ADJUSTING EROSION CONTROL FACILITIES AS SITE CONDITIONS CHANGE REFER TO T.E.S. NOTES AND DETAILS ON SHEET C2.1
- CONTRACTOR SHALL DESIGNATE A WASHINGTON STATE CERTIFIED EROSION AND SEDIMENT CONTROL LEAD (CESCL) WHO WILL BE ON-SITE OR ON CALL AT ALL TIMES THE EROSION CONTROL LEAD SHALL HAVE THE AUTHORITY TO IMPLEMENT THE STORMWATER POLLUTION PREVENTION PLAN BASED ON SITE CONDITIONS WITHIN THEIR IF THE METHODS INDICATED FOR EROSION AND SEDIMENT CONTROL ARE NOT ADEQUATE, THE CESCL SHALL
- IMPLEMENT ADDITIONAL METHODS AS REQUIRED. 3. CONTRACTOR SHALL IMPLEMENT AND CHANGE EROSION CONTROL MEASURES AS NECESSITATED BY CONSTRUCTION ACTIVITIES.
- 4. CONTRACTOR SHALL MAINTAIN BMP C150: MATERIALS ON HAND, ON-SITE IN AN AREA EASILY ACCESSIBLE. REFER TO SWPPP FOR BMP DESCRIPTION AND INFORMATION.
- 5. CONTRACTOR TO FOLLOW BMP C153: MATERIAL DELIVERY STORAGE AND CONTAINMENT IN THE STORAGE OF HAZARDOUS MATERIALS ONSITE.REFER TO SWPPP FOR BMP DESCRIPTION AND INFORMATION.
- 6. THIS TESC PLAN SHALL BE USED IN CONJUNCTION WITH THE CONSTRUCTION SWPPP AND MAY BE MODIFIED AS SITE CONDITIONS CHANGE BY THE CESCL. 7. SWEEP ADJACENT STREETS DAILY, AS REQUIRED BY THE
- CITY OF TACOMA INSPECTOR AND AT COMPLETIONS OF PROJECT. SEDIMENT TRACKED ONTO CITY STREETS MUST BE SWEPT IMMEDIATELY.
- 8. PROVIDED PLASTIC, STRAW, OR OTHER APPROPRIATE BMP ON DISTURBED SOILS NOT BEING WORKED FOR SHORT PERIODS OF TIME DURING THE DRY SEASON. REFER TO THE CSWPPP FOR STABILIZATION REQUIREMENTS DURING THE WET SEASON AND FOR EXTENDED TIME PERIODS.
- 9. MAINTAIN EXISTING PAVEMENT FOR CONSTRUCTION STAGING AND LAY DOWN AS LONG AS FEASIBLE. SWEEP AS NECESSARY TO PREVENT DEBRIS AND SEDIMENT FROM ENTERING STORM SYSTEM.
- 10. THE PROPOSED STORM SYSTEM CAN BE USED TO COLLECT AND CONVEY STORMWATER DURING CONSTRUCTION. CONSTRUCTION STORMWATER SHALL NOT BE RELEASED WITHOUT TREATMENT TO APPROPRIATE TURBIDITY LEVELS. STORM SYSTEM SHALL BE CLEANED PRIOR TO ACCEPTANCE.

WET WEATHER NOTE

SITE SOILS ARE CONSIDERED TO BE MOISTURE SENSITIVE AND CANNOT BE ADEQUATELY COMPACTED DURING WET WEATHER CONDITIONS. CONTRACTOR MAY NEED TO REMOVE EXCESSIVELY SATURATED SOILS OR PROVIDED COVER METHODS IF CONSTRUCTION DURING WET WEATHER, REFER TO GEO-TECHNICAL REPORT

CESCL NOTE

A CERTIFIED EROSION AND SEDIMENT CONTROL LEAD (CESCL), OR CERTIFIED PROFESSIONAL IN EROSION AND SEDIMENT CONTROL IS REQUIRED FOR THE PROJECT. THE NAMED PERSON OR FIRM SHALL BE ON SITE OR ON-CALL AT ALL TIMES. CONTACT: MR. CALEB HILGER PHONE: 253.584.4766

EMERGENCY CONTACT

A 24-HOUR EMERGENCY CONTACT IS REQUIRED FOR THIS PROJECT. CONTACT: MR. CALEB HILGER ADDRESS: 10905 25TH AVE E, TACOMA WA 98445 PHONE: 253.584.4766

BASIS OF BEARING

HELD SOUTH 88°42'01" EAST BETWEEN CITY OF TACOMA CONTROL MONUMENTS #1220 AND #1033

HORIZONTAL DATUM

WASHINGTON STATE PLAN COORDINATE SYSTEM, SOUTH ZONE (NAD 83/91)

BASED ON TIES CITY OFTACOMA MONUMENTS #34, 1033, 1219 AND 1220.

COT MONUMENT #1220

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FOUND 3" BRASS DISK W/PUNCH ON SURFACE AT INTX. OF S. 38TH ST. AND UNION AVE.

VERTICAL DATUM

CITY OF TACOMA NGVD 29


BENCHMARK 3760

DESC "X" ON SE BOLT OF STREET LIGHT POLE AT THE SE CORNER OF THE INTERSECTION OF S 38TH STREET AND SOUTH TACOMA WAY. ELEV: 263.28'





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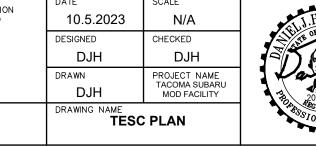


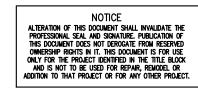






TELD BOOKS REVISION DATE APPD



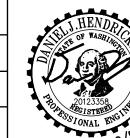

SITE AND BUILDING DIVISION


CITY OF TACOMA DEPARTMENT OF PUBLIC WORKS

> TACOMA SUBARU MOD FACILITY 3812 SOUTH TACOMA WAY, TACOMA, WA 98409 SITE DEVELOPMENT PERMIT SET

SDEV23-0202


C1.0

1" = 20 FEET

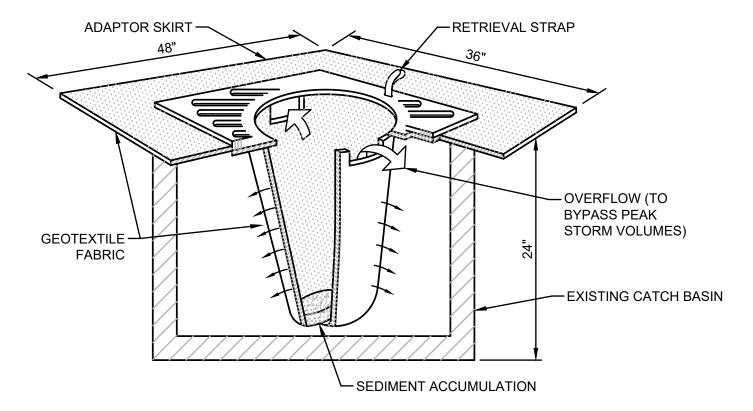

- 1. FILTERS SHALL BE INSPECTED AFTER EACH STORM EVENT AND
- CLEANED OR REPLACED WHEN 1/3 FULL.
- 2. INSTALL INLET PROTECTION IN ALL NEW STORM STRUCTURES THAT WILL COLLECT STORMWATER AS THEY ARE INSTALLED.
- 3. PROTECT ALL DOWNSTREAM INLETS WITHIN 200 FT OF THE



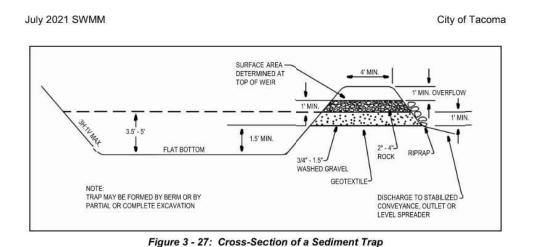


MIN. OVERFLOW SPILLWAY MIN. 1' DEPTH NATIVE SOIL OR-COMPACTED 2"-4" ROCK BACKFILL MIN. 1' DEPTH GEOTEXTILE 34"-1.5" WASHED GRAVEL


Figure 3 - 28: Sediment Trap Outlet

SEDIMENT TRAP AND OVERFLOW

PLASTIC COVERING NOTES


- 1. PLASTIC SHEETING SHALL HAVE A MINIMUM THICKNESS OF 6 MILS AND SHALL MEET THE REQUIREMENTS OF THE STATE STANDARD SPECIFICATIONS SECTION 9-14.5.
- 2. COVERING SHALL BE INSTALLED AND MAINTAINED TIGHTLY IN PLACE BY USING SANDBAGS OR TIRES ON ROPES WITH A MAXIMUM 10-FOOT GRID SPACING IN ALL DIRECTIONS. ALL SEAMS SHALL BE TAPED OR WEIGHTED DOWN FULL LENGTH AND THERE SHALL BE AT LEAST A 12 INCH OVERLAP OF
- ALL SEAMS. 3. CLEAR PLASTIC COVERING SHALL BE INSTALLED IMMEDIATELY ON AREAS SEEDED BETWEEN
- OCTOBER 1ST AND APRIL 30TH AND REMAIN UNTIL VEGETATION IS FIRMLY ESTABLISHED. 4. WHEN THE COVERING IS USED ON UN-SEEDED SLOPES, IT SHALL BE KEPT IN PLACE UNTIL THE NEXT
- 5. PLASTIC COVERING SHEET SHALL BE BURIED TWO FEET AT THE TOP OF SLOPES IN ORDER TO PREVENT SURFACE WATER FLOW BENEATH SHEETS
- 6. PROPER MAINTENANCE INCLUDES REGULAR CHECKS FOR RIPS AND DISLODGED ENDS.

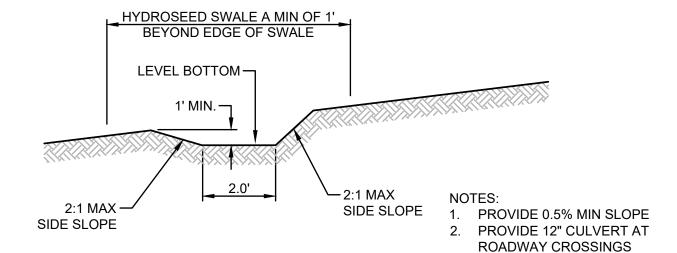

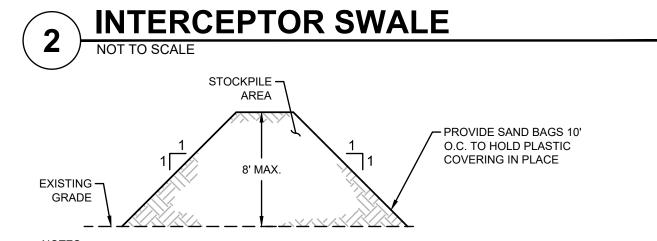

- 1. STOCKPILES SHALL BE STABILIZED WITH PLASTIC COVERING OR OTHER APPROVED
- SEDIMENT LEACHING FROM STOCKPILES SHALL BE PREVENTED DURING ALL



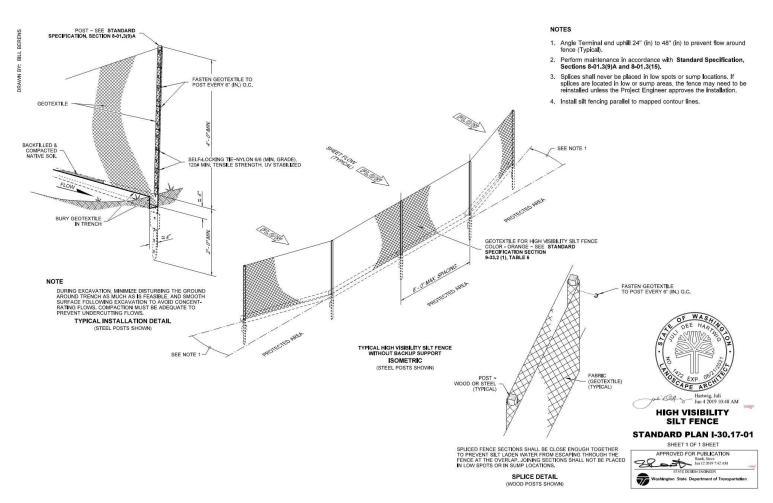

SILT FENCE

ADDITIONAL EROSION CONTROL NOTES

- ONSITE EROSION CONTROL MEASURES SHALL BE THE RESPONSIBILITY OF THE CONTRACTOR. ANY PROBLEMS OCCURRING BEFORE FINAL ACCEPTANCE OF THE STORM SYSTEM BY THE MUNICIPALITY SHALL BE CORRECTED BY
- THE CONTRACTOR. 2. IN CASE EROSION OR SEDIMENTATION OCCURS TO ADJACENT PROPERTY, ALL CONSTRUCTION WORK WITHIN THE DEVELOPMENT THAT WILL AGGRAVATE THE SITUATION MUST CEASE AND THE APPLICANT/CONTRACTOR SHALL IMMEDIATELY COMMENCE RESTORATION OR MITIGATION MEASURES. RESTORATION ACTIVITY SHALL CONTINUE UNTIL SUCH TIME AS THE PROBLEM IS RECTIFIED.
- 3. ALL EROSION AND SEDIMENTATION CONTROL DEVICES SHOWN ON THIS DRAWING SHALL BE INSTALLED PRIOR TO OR AS THE FIRST STAGE OF SITE PREPARATION.
- 4. SHOULD THE TEMPORARY EROSION AND SEDIMENTATION CONTROL MEASURES AS SHOWN ON THIS DRAWING NOT PROVE ADEQUATE TO CONTROL EROSION AND SEDIMENTATION, THE CONTRACTOR SHALL INSTALL ADDITIONAL FACILITIES AS NECESSARY TO PROTECT ADJACENT PROPERTIES, SENSITIVE AREAS, NATURAL WATER COURSES, AND OR STORM DRAINAGE SYSTEM. COORDINATE ADDITIONAL FACILITIES WITH OWNER
- 5. THE PROJECT SURVEYOR WILL BE RESPONSIBLE FOR FIELD LOCATING THE CLEARING LIMITS AND ESTABLISHING THOSE BOUNDARIES WITH BRIGHT COLORED FLAGGING. THE CONTRACTOR SHALL CLEAR TO THE LIMITS AS ESTABLISHED ON THIS PLAN AND AS FLAGGED IN THE FIELD.
- 6. ALL WORK ASSOCIATED WITH STABILIZING THE DISTURBED AREAS SHALL BE IN ACCORDANCE WITH THE CITY OF TACOMA STORMWATER MANAGEMENT MANUAL
- 7. ALL NECESSARY FACILITIES SHALL BE MAINTAINED ON SITE TO PREVENT DEBRIS, DUST, AND MUD FROM ACCUMULATING ON THE PUBLIC RIGHT OF WAY.

MULCHING NOTES:

- 1. MULCH MATERIALS USED SHALL BE STRAW AND SHALL BE APPLIED AT THE RATE OF 1.5 TO 2.5 TONS/ACRE MIN 2" THICK.
- 2. MULCHES SHALL BE APPLIED IN ALL AREAS WITH EXPOSED SLOPES GREATER THAN 2:1.
- 3. MULCHING SHALL BE USED IMMEDIATELY AFTER SEEDING OR IN AREAS WHICH CANNOT BE SEEDED BECAUSE OF THE
- 4. ALL AREAS NEEDING MULCH SHALL BE COVERED BY NOVEMBER FIRST (1).

SOIL STOCKPILE NOTES

- STOCKPILES SHALL BE STABILIZED (WITH PLASTIC COVERING OR OTHER APPROVED DEVICE) DAILY BETWEEN OCTOBER 1 TO APRIL 30.
- 2. IN ANY SEASON, SEDIMENT LEACHING FROM STOCK PILES MUST BE PREVENTED.
- TOPSOIL SHALL NOT BE PLACED WHILE IN A FROZEN OR MUDDY CONDITION, WHEN THE SUBGRADE IS EXCESSIVELY WET OR WHEN CONDITIONS EXIST THAT MAY OTHERWISE BE DETRIMENTAL TO PROPER GRADING OR PROPOSED SODDING OR
- APPROVED PLAN.
- 5. ALL STOCKPILES SHALL BE COVERED WITH PLASTIC COVERING. SEE PLASTIC COVERING NOTES ON THIS SHEET

4. PREVIOUSLY ESTABLISHED GRADES ON THE AREAS TO BE TOPSOILED SHALL BE MAINTAINED ACCORDING TO THE



HYDROSEEDING NOTES

- 1. HYDROSEEDING SHALL BE APPLIED IN ACCORDANCE WITH THE "T.E.S.C. NOTES" ON THIS SHEET
- 2. HYDROSEEDING TO BE THE FOLLOWING MIXTURE:

| COMMON NAME | % BY WEIGHT | % PURITY | %GERMINATION |
|--|-------------|----------|--------------|
| REDTOP (AGOTSTIS ALBA) | 10 | 92 | 90 |
| ANNUAL RYE (LOLIUM MULTIFORUM) | 45 | 98 | 90 |
| CHEWING FESCUE(FESTUCE RUBRA COMMUT. (JAMESTOWN, BANNER, SHODOW, OR KOKET) | , | 97 | 80 |

- APPLICATION TO BE 100LBS/ACRE
- 4. 500 LBS/ACRE 10-20-20 FERTILIZER, 1500 LBS/ACRE WOOD FIBER CELLULOSE WITH SOIL BINDER OR TACKING AGENT TO BE APPLIED WITH SEED MIXTURE.
- SEED BEDS PLANTED BETWEEN MAY 1 AND AUGUST 31 WILL REQUIRE IRRIGATION AND OTHER MAINTENANCE AS NECESSARY TO FOSTER AND PROTECT THE ROOT STRUCTURE.
- FOR SEED BEDS PLANTED BETWEEN OCTOBER 31 AND APRIL 30, ARMORING OF THE SEED BED WILL BE NECESSARY. (E.G., GEOTEXTILES, JUTE MAT, CLEAR PLASTIC COVERING.)
- BEFORE SEEDING, INSTALL NEEDED SURFACE RUNOFF CONTROL MEASURES SUCH AS GRADIENT TERRACES, INTERCEPTOR DIKES, SWALES, LEVEL SPREADERS AND SEDIMENT BASINS.
- 8. THE SEEDBED SHALL BE FIRM WITH A FAIRLY FINE SURFACE, FOLLOWING SURFACE ROUGHENING. PERFORM ALL OPERATIONS ACROSS OR AT RIGHT ANGLES TO THE SLOPE.
- FERTILIZERS ARE TO BE USED ACCORDING TO SUPPLIERS RECOMMENDATIONS. AMOUNTS USED SHOULD BE MINIMIZED, ESPECIALLY ADJACENT TO WATER BODIES AND WETLANDS.
- 10. SEED SHALL NOT BE USED IN AREAS SUBJECT TO WEAR BY CONSTRUCTION TRAFFIC.

SITE AND BUILDING DIVISION


STANDARD TESC NOTES

- THE IMPLEMENTATION OF THESE TESC PLANS AND THE CONSTRUCTION MAINTENANCE, REPLACEMENT AND UPGRADING OF TESC FACILITIES IS THE RESPONSIBILITY OF THE APPLICANT/CONTRACTOR UNTIL ALL CONSTRUCTION IS COMPLETED AND APPROVED, VEGETATION IS ESTABLISHED AND THE ENTIRE SITE IS STABILIZED.
- THE BOUNDARIES OF THE CLEARING LIMITS SHOWN ON THIS PLAN SHALL BE CLEARLY FLAGGED IN THE FIELD PRIOR TO CONSTRUCTION, DURING THE CONSTRUCTION PERIOD, NO DISTURBANCE BEYOND THE FLAGGED LIMITS SHALL BE PERMITTED. THE FLAGGING SHALL BE MAINTAINED BY THE APPLICANT/CONTRACTOR FOR THE DURATION OF
- 3. THE TESC FACILITIES SHOWN ON THIS PLAN SHALL BE CONSTRUCTED PRIOR TO AND/OR IN CONJUNCTION WITH ALL CLEARING AND GRADING ACTIVITIES, AND IS SUCH A MANNER AS TO ENSURE THAT SEDIMENT AND SEDIMENT LADEN WATER DO NOT ENTER THE DRAINAGE SYSTEM OR ROADWAYS OR VIOLATE APPLICABLE WATER STANDARDS.
- THE TESC SHOWN ON THIS PLAN ARE MINIMUM REQUIREMENTS FOR ANTICIPATED SITE CONDITIONS. DURING THE CONSTRUCTION PERIOD. TESC FACILITIES SHALL BE UPGRADED AS NEEDED FOR UNEXPECTED STORM EVENTS AND TO ENSURE THAT SEDIMENT AND SEDIMENT LADEN WATERS DO NOT LEAVE THE SITE.
- THE TESC FACILITIES SHALL BE INSPECTED DAILY BY THE APPLICANT/CONTRACTOR AND MAINTAINED AS NECESSARY TO ENSURE THEIR CONTINUED FUNCTION.
- THE TESC FACILITIES ON INACTIVE SITES SHALL BE INSPECTED AND MAINTAINED A MINIMUM OF ONCE A MONTH OR WITHIN
- THE 48 HOURS FOLLOWING A MAJOR STORM EVENT OR AS NECESSARY TO ENSURE THEIR CONTINUED FUNCTION. ALL CATCH BASINS AND CONVEYANCE LINES SHALL BE CLEANED PRIOR TO PAVING. THE CLEANING OPERATION SHALL NOT FLUSH SEDIMENT LADEN WATER INTO THE DOWNSTREAM SYSTEM.
- STABILIZED CONSTRUCTION ENTRANCES SHALL BE INSTALLED AT THE BEGINNING OF CONSTRUCTION AND MAINTAIN FOR THE DURATION OF THE PROJECT. ADDITIONAL MEASURES MAY BE REQUIRED TO ENSURE THAT ALL PAVED AREAS ARE KEPT CLEAN FOR THE DURATION OF THE PROJECT.







6909 FORD DR NW, GIG HARBOR, WA 98335 TEL: 253.514.2413

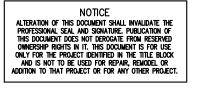




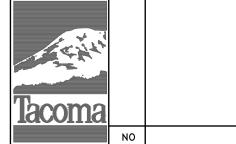

| | | | | | FINAL CONSTRUCTION | DATE | SCALE |
|--------------|----|----------|------|------|-----------------------|--------------|-------------------------------|
| | | | | | CHECKED | 10.5.2023 | N/A |
| 1 X X X | | | | | | DESIGNED | CHECKED |
| - | | | | | BY | DJH | DJH |
| and the same | | | | | DATE | DRAWN | PROJECT NAME |
| 0.500 | | | | | | DJH | TACOMA SUBARU MOD FACILITY |
| oma | | | | | FIELD BOOKS | DRAWING NAME | AND DETAILS |
| | NO | REVISION | DATE | APPD | | IESC NOTES | AND DETAILS |

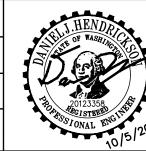

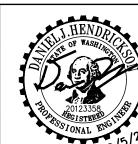


DEPARTMENT OF PUBLIC WORKS TACOMA SUBARU MOD FACILITY 3812 SOUTH TACOMA WAY, TACOMA, WA 98409

SITE DEVELOPMENT PERMIT SET


CITY OF TACOMA

SDEV23-0202 C1.1

3 OF 12

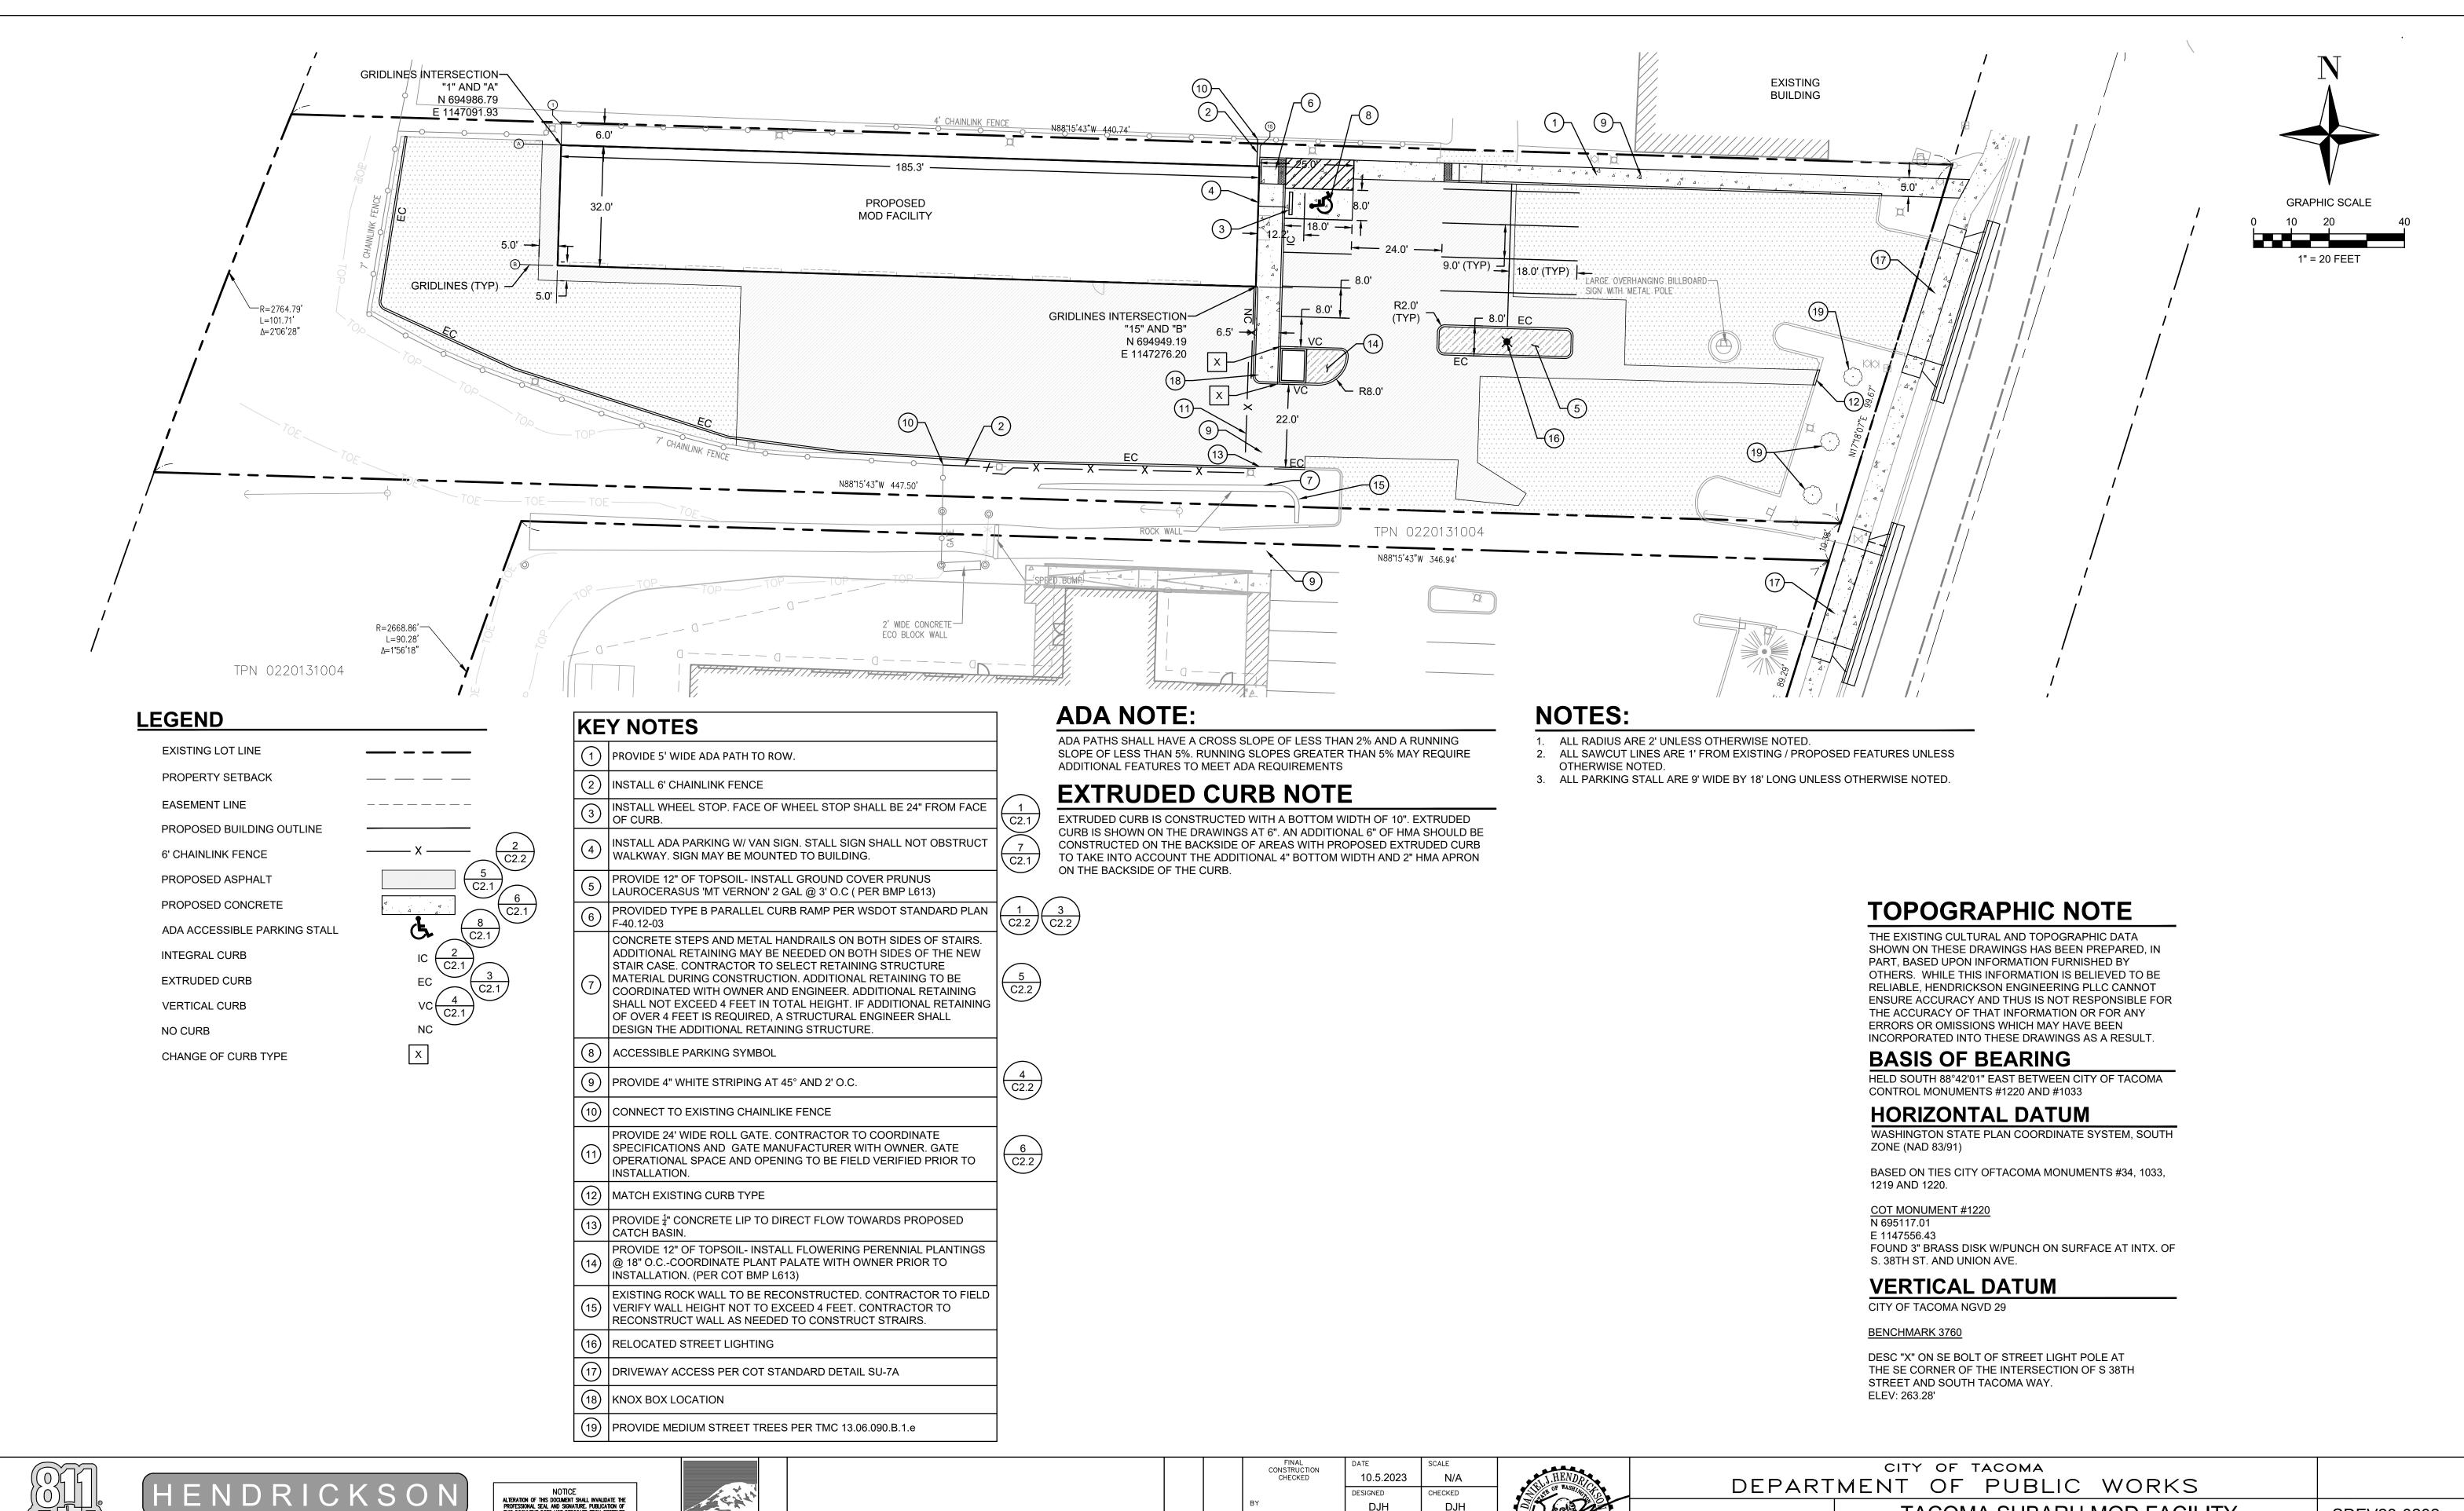

ENGINEERING

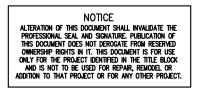










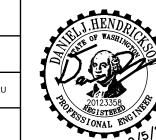

DJH




SITE AND BUILDING DIVISION


DEPARTMENT OF PUBLIC WORKS

TACOMA SUBARU MOD FACILITY 3812 SOUTH TACOMA WAY, TACOMA, WA 98409 SITE DEVELOPMENT PERMIT SET

SDEV23-0202

C2.0

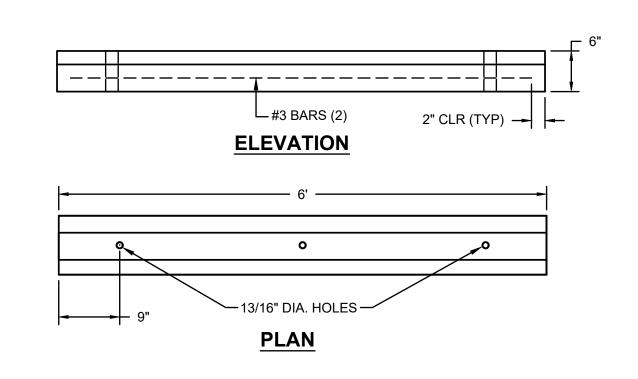


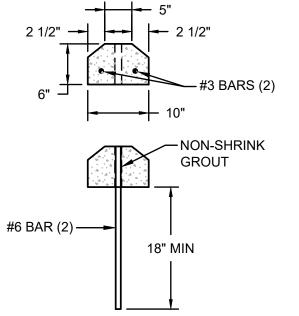


- 1. THE NON-SHRINK GROUT USED TO ATTACH THE PRECAST CURB SHALL CONSIST OF 3:1 SAND AND CEMENT. GROUT TO A DEPTH OF 1" FROM THE TOP OF THE BUMPER.
- 2. LOCATIONS FOR WEEPHOLES, AND V-SLOTS SHALL BE IDENTIFIED ON THE DELIVERY ORDER DRAWINGS.
- 3. CONCRETE SHALL HAVE A COMPRESSIVE STRENGTH OF 3000 PSI AT 28 DAYS.

ATTACHMENT DETAIL



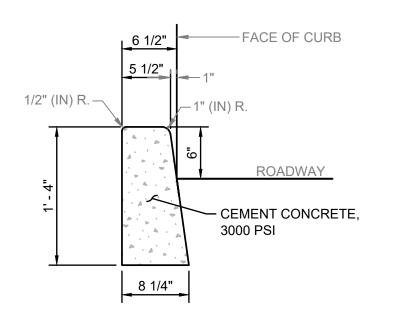



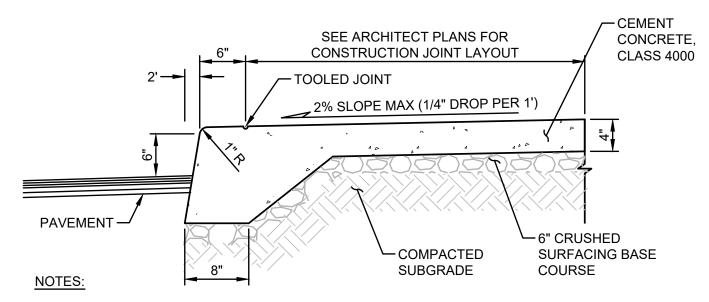


- 1. SUBGRADE COMPACTION FOR CONCRETE CURB AND WALKS SHALL BE 95% OF MAXIMUM DENSITY.
- 2. EXPANSION JOINTS CONSISTING OF 3/16" BY 2" PREMOLDED JOINT MATERIAL SHALL BE PLACED AT 15 FOOT INTERVALS. SEALED WITH POLYURETHANE TO MATCH WALK

INTEGRAL CURB 6" ASPHALT **BEHIND BACK** FACE OF CURB 1-1/2" R -(TYP) DEPTH OF _ THRU JOINT 1" R (TYP) THE ADHESIVE SHALL MEET THE - ADHESIVE, SEE NOTE REQUIREMENTS OF SECTION 9-26.1 FOR TYPE-II EPOXY



BONDING AGENT

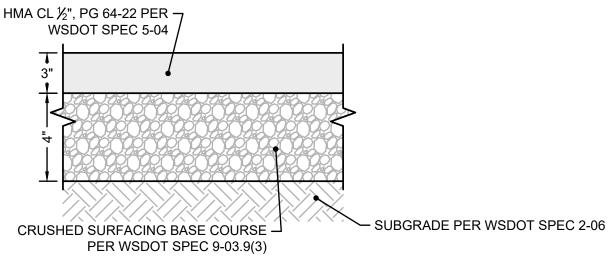


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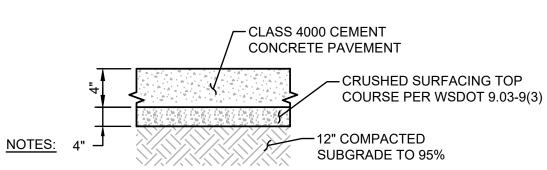
1. DEPTHS INDICATED ARE COMPACTED THICKNESSES.

- 2. HMA SHALL BE COMPACTED TO A TARGET AVERAGE DENSITY OF 92% BASED ON THE RICE THEORETICAL MAXIMUM DENSITY PER ASTM D-2041. INDIVIDUAL LOCATIONS SHALL BE COMPACTED NOT LESS THAN 90% NOR MORE THAN 96%.
- 3. UP TO 20% BY WEIGHT OF THE ASPHALT BASE MATERIAL MAY BE SUBSTITUTED WITH CRUSHED CEMENT CONCRETE, PROVIDED THAT THE FINAL MIXTURE MEETS THE SAME TEXTURAL CRITERIA AS THE
- SPECIFIED WSDOT MATERIAL. 4. GRANULAR SUBBASE SHALL CONSIST OF "BALLAST" PER WSDOT 9-03.9(1), "GRAVEL BORROW" PER WSDOT 9-03.14, OR CRUSHED RECYCLED CONCRETE PROVIDED THAT IT MEETS THE SAME TEXTURAL
- 5. ALL ASPHALT BASE MATERIAL SHALL BE COMPACTED TO A MINIMUM DENSITY OF 95% BASED ON THE MODIFIED PROCTOR MAXIMUM DRY DENSITY PER ASTM D-1557.
- 6. SUBGRADE SHALL BE COMPACTED TO A FIRM AND UNYIELDING CONDITION PRIOR TO PLACEMENT OF ANY PAVEMENT LAYERS. ANY LOCALIZED ZONES OF SOFT, ORGANIC-RICH, OR DEBRIS-LADEN SOILS SHOULD BE OVEREXCAVATED AND REPLACED WITH STRUCTURAL FILL MATERIAL.

ASPHALT SECTION


CRITERIA AS "BALLAST" OR "GRAVEL BORROW."



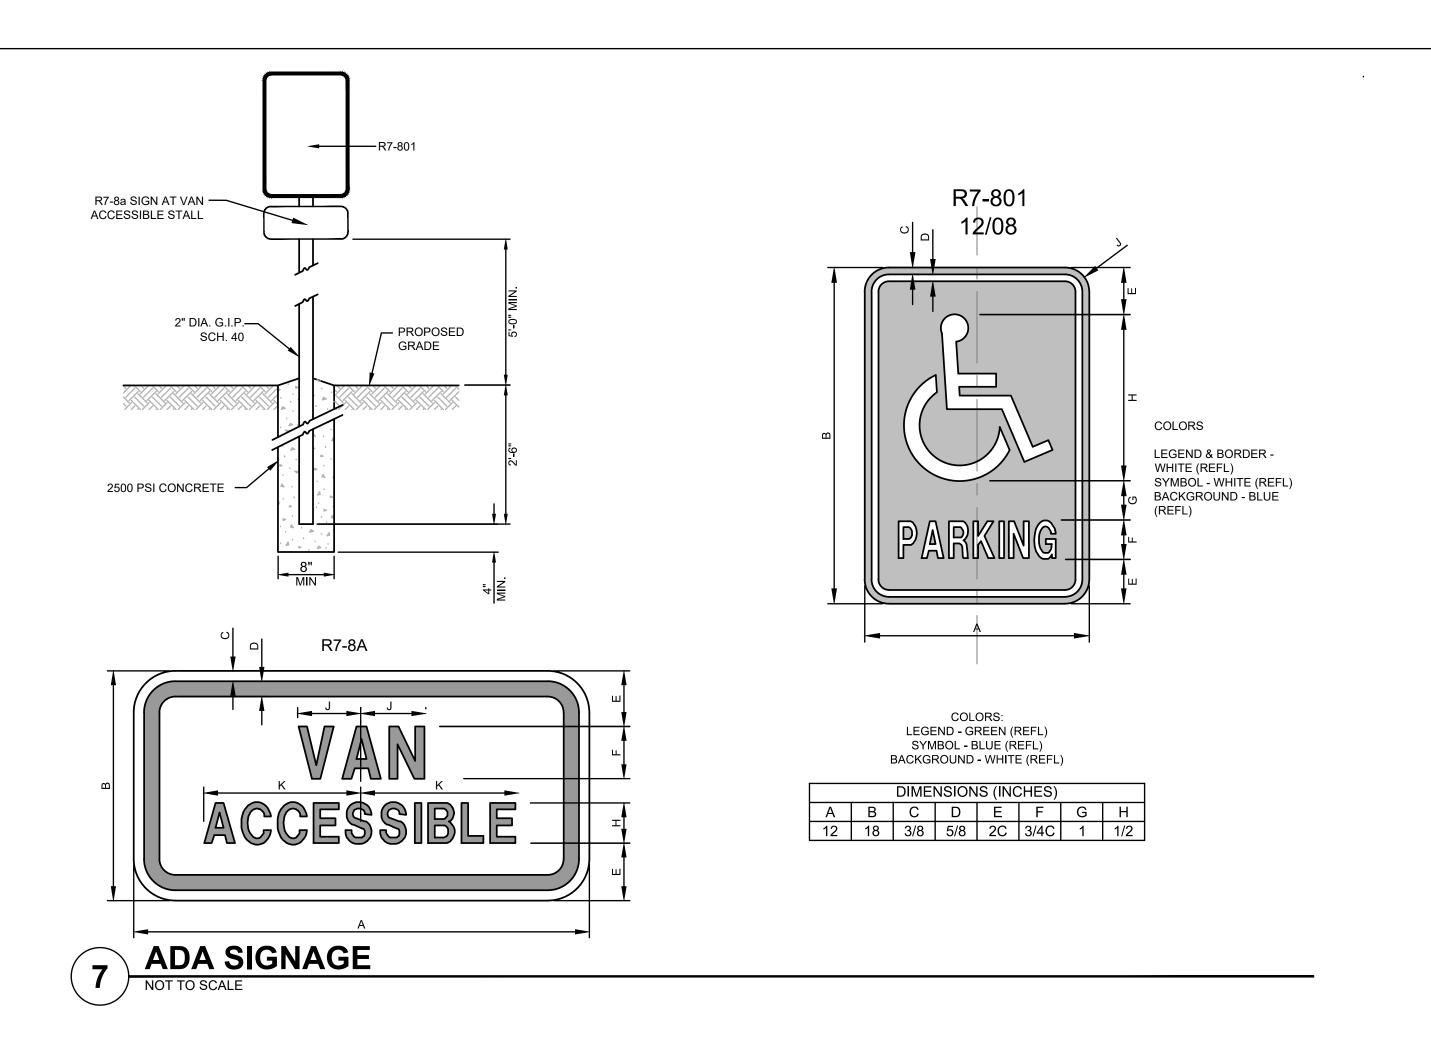

- 1. DEPTHS ARE COMPACTED THICKNESS.
- 2. DUMMY JOINTS CONSISTING OF 3/16" BE 2" PREMOLDED JOINT MATERIAL SHALL BE PLACED AT MAXIMUM 10 FOOT INTERVALS.
- 3. PROVIDE A TOOLED CONSTRUCTION JOINT AT MAXIMUM 6 FOOT INTERVAL.
- 4. THE CONTRACTOR SHALL EXPOSE EXISTING FILL, PROOF ROLL AND COMPACT TO 95%. IF YIELDING CONDITIONS ARE ENCOUNTERED, YIELDING MATERIALS SHALL BE REPLACED WITH IMPORTED STRUCTURAL FILL MATERIAL. THE DEPTH OF MATERIAL REPLACEMENT SHALL BE DETERMINED BY THE GEOTECHNICAL ENGINEER.



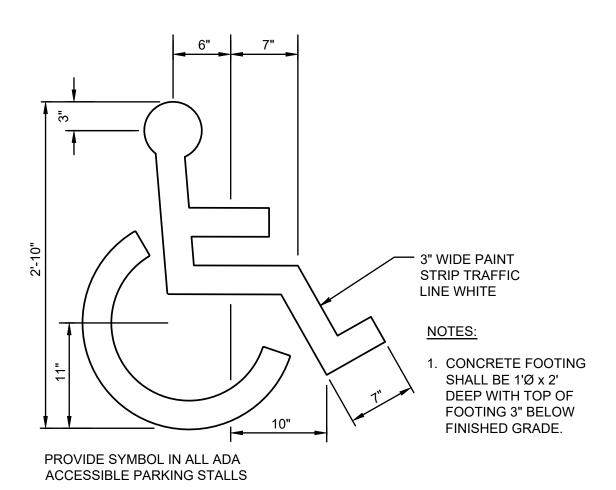








HENDRICKSON ENGINEERING


6909 FORD DR NW, GIG HARBOR, WA 98335 TEL: 253.514.2413

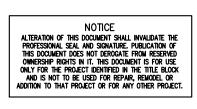



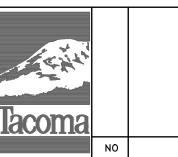

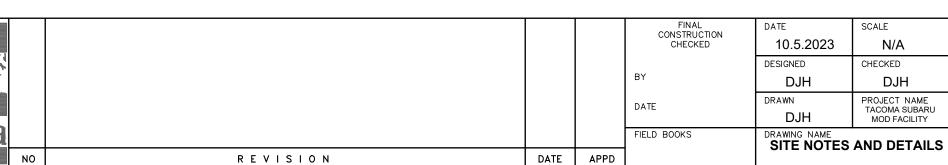

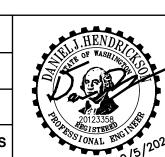


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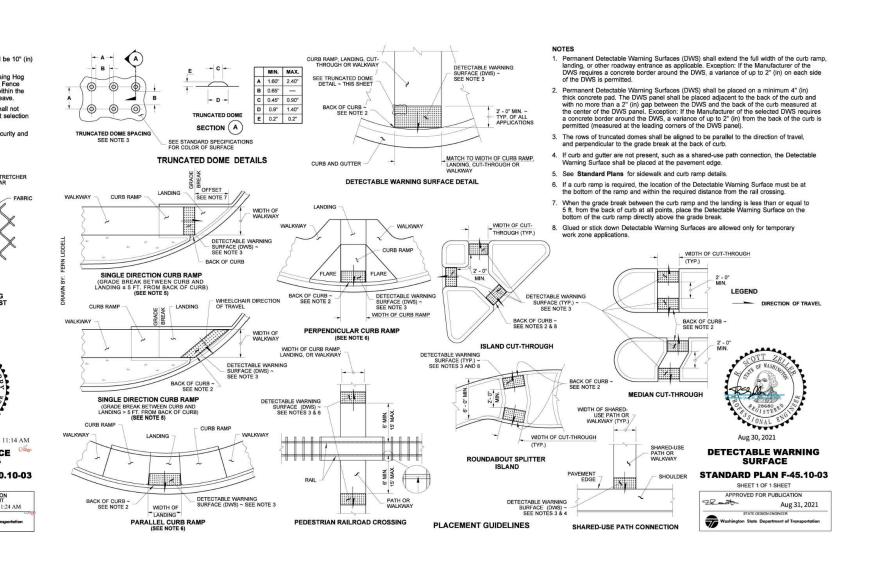
DEPARTMENT OF PUBLIC WORKS TACOMA SUBARU MOD FACILITY 3812 SOUTH TACOMA WAY, TACOMA, WA 98409 SITE DEVELOPMENT PERMIT SET

CITY OF TACOMA

SDEV23-0202 C2.1

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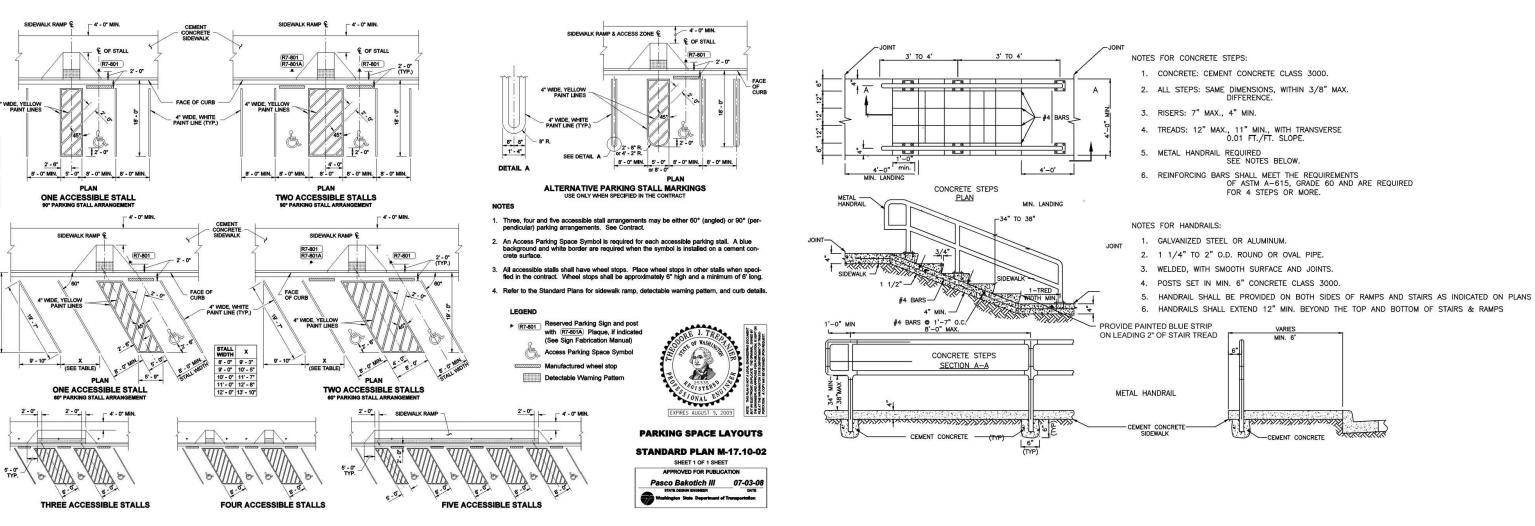





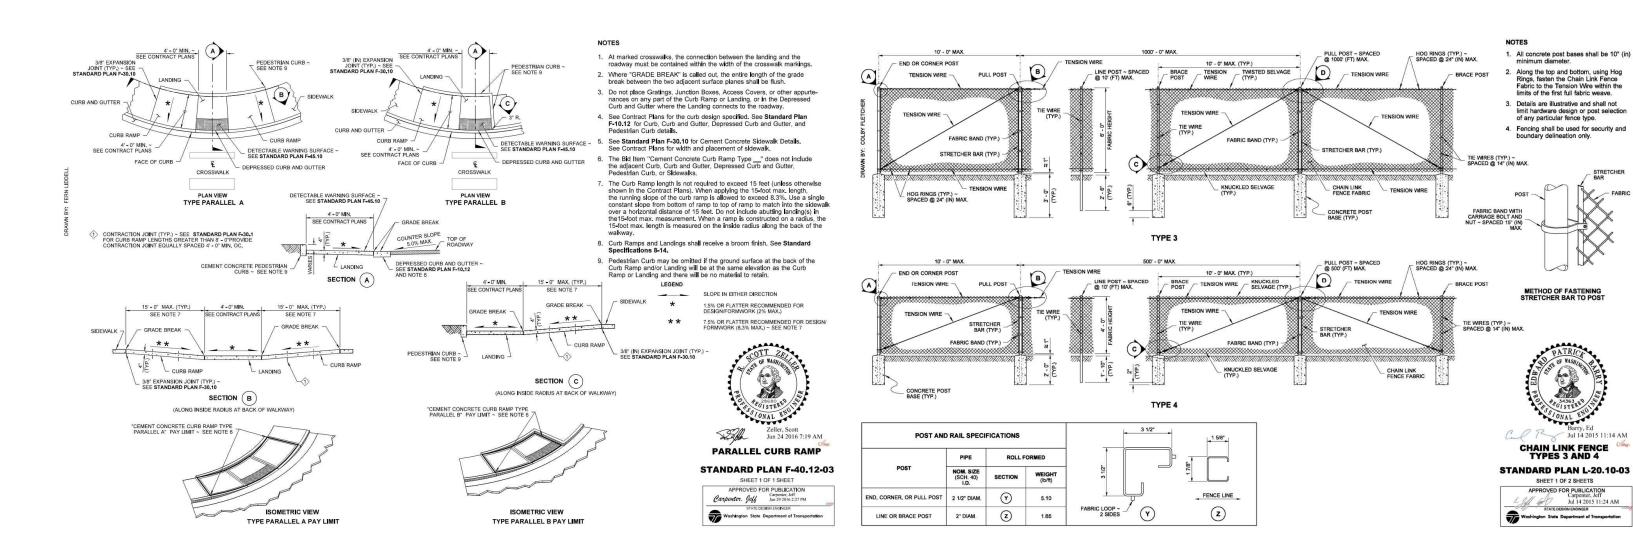







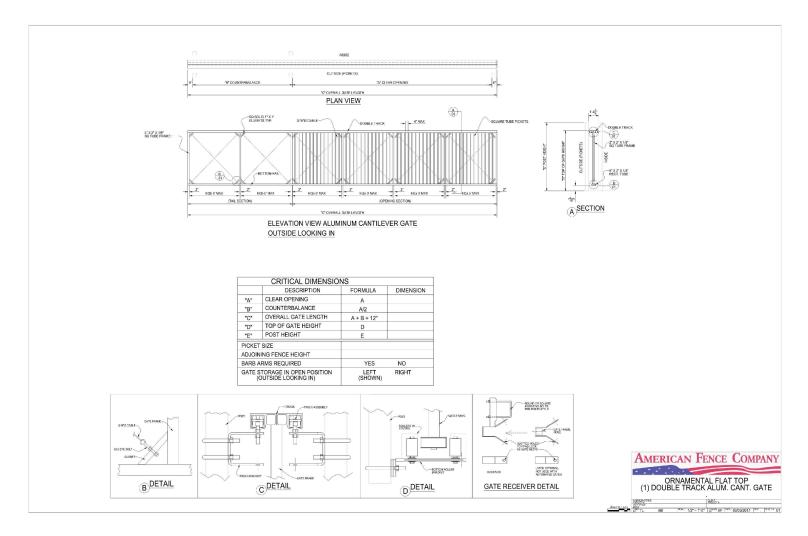




CONCRETE STEPS AND METAL HANDRAIL


SLIDE GATE




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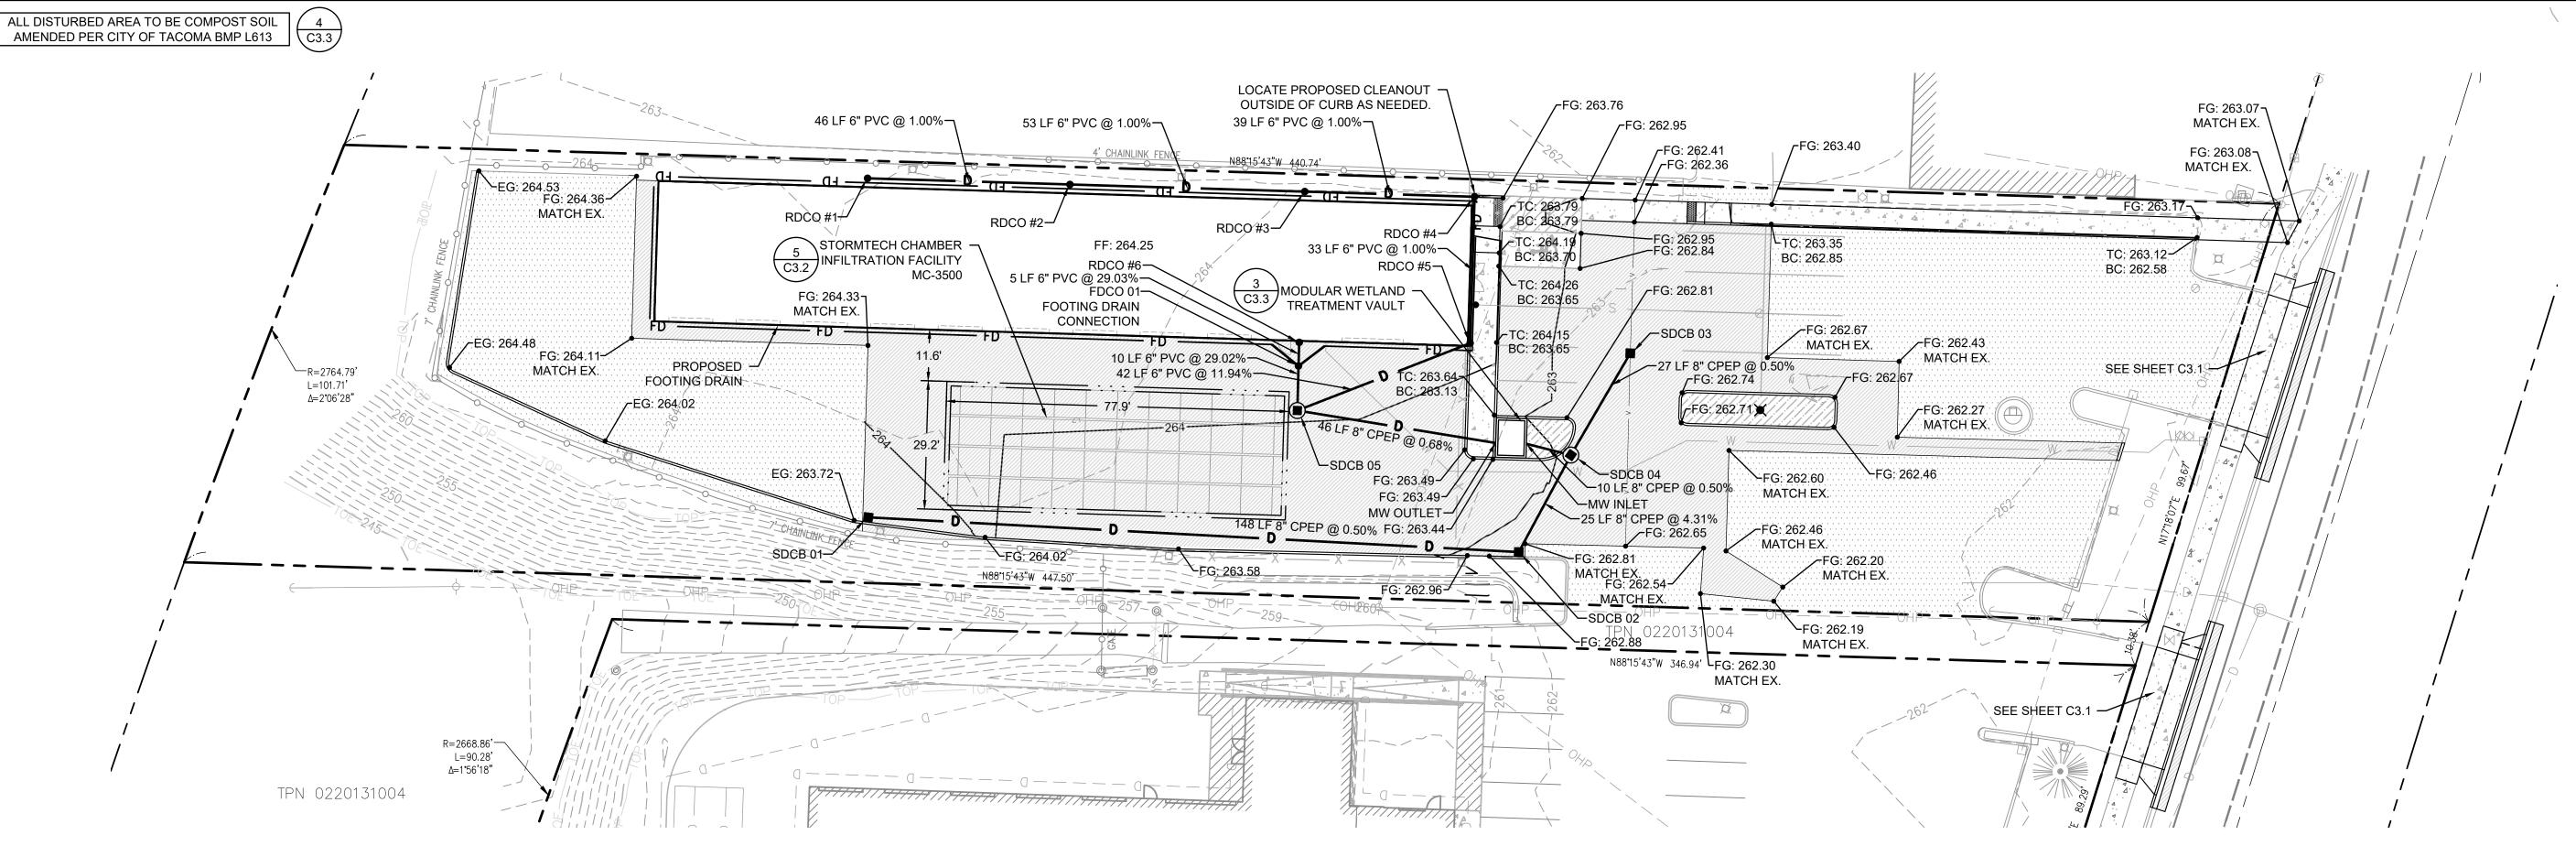
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PROJECT NAME

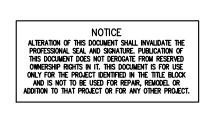CITY OF TACOMA DEPARTMENT OF PUBLIC WORKS

TACOMA SUBARU MOD FACILITY 3812 SOUTH TACOMA WAY, TACOMA, WA 98409 SITE DEVELOPMENT PERMIT SET

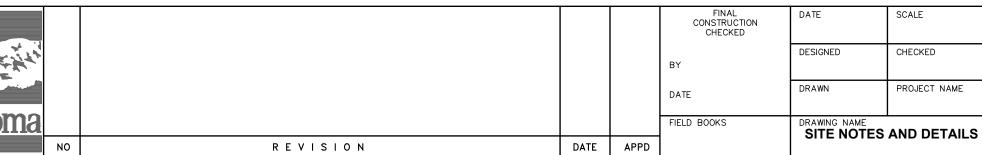C2.2

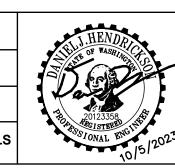

LEGEND

VALLEY FLOWLINE

TYPE 1 CATCH BASIN TYPE 2 MANHOLE **ROOF DRAIN CLEANOUT** PROPOSED STORM DRAIN PIPE PROPOSED ROOF DRAIN PIPE FOOTING DRAIN **EXISTING MINOR CONTOUR** ----XXX-----**EXISTING MAJOR CONTOUR** — —XXX— — – PROPOSED MINOR CONTOUR ——XXX—— PROPOSED MAJOR CONTOUR —___XXX—___

_____ v ____

EARTHWORK QUANTITIES

CUT = 37 CU. YDS FILL = 120 CU. YDS NET = 83 CU. YDS (FILL)

THE ABOVE QUANTITIES ARE ESTIMATES ONLY INTENDED FOR THE PERMITTING PROCESS. DO NOT USE FOR BID PURPOSES. THE QUANTITIES DO NOT HAVE STRIPPING, COMPACTION, OR CUT OR FILL ADJUSTMENT FACTORS APPLIED TO THEM, NOR DO THEY ACCOUNT FOR ROADWAY SECTION.

TOPOGRAPHIC NOTE

THE EXISTING CULTURAL AND TOPOGRAPHIC DATA SHOWN ON THESE DRAWINGS HAS BEEN PREPARED, IN PART. BASED UPON INFORMATION FURNISHED BY OTHERS. WHILE THIS INFORMATION IS BELIEVED TO BE RELIABLE, HENDRICKSON ENGINEERING PLLC CANNOT ENSURE ACCURACY AND THUS IS NOT RESPONSIBLE FOR THE ACCURACY OF THAT INFORMATION OR FOR ANY ERRORS OR OMISSIONS WHICH MAY HAVE BEEN INCORPORATED INTO THESE DRAWINGS AS A RESULT.

BASIS OF BEARING

HELD SOUTH 88°42'01" EAST BETWEEN CITY OF TACOMA CONTROL MONUMENTS #1220 AND #1033

HORIZONTAL DATUM

WASHINGTON STATE PLAN COORDINATE SYSTEM, SOUTH ZONE (NAD 83/91)

BASED ON TIES CITY OFTACOMA MONUMENTS #34, 1033, 1219 AND 1220.

COT MONUMENT #1220 N 695117.01

E 1147556.43

FOUND 3" BRASS DISK W/PUNCH ON SURFACE AT INTX. OF S. 38TH ST. AND UNION AVE.

VERTICAL DATUM

CITY OF TACOMA NGVD 29

BENCHMARK 3760

DESC "X" ON SE BOLT OF STREET LIGHT POLE AT THE SE CORNER OF THE INTERSECTION OF S 38TH STREET AND SOUTH TACOMA WAY. ELEV: 263.28'

DRAINAGE NOTE

- 1. ALL CATCH BASINS SHALL HAVE VANED GRATES UNLESS OTHERWISE
- 2. PIPE COVER SHALL BE A MINIMUM OF 2' FOR CPEP AND 1' FOR DUCTILE
- 3. ALL ROOF DRAINS TO BE RIGID PVC UNLESS OTHERWISE NOTED.
- 4. PIPE BEDDING AND BACKFILL SHALL BE PER DETAIL.
- 5. ALL STORM PIPES SHALL BE CPEP UNLESS OTHERWISE NOTED. CPEP PIPES SHALL BE ADS N-12 OR APPROVED EQUAL.
- 6. PROPOSED PIPE LENGTHS AND HORIZONTAL CONTROL ARE PROVIDED TO CENTER OF STRUCTURE UNLESS OTHERWISE NOTED.
- 7. ALL ELEVATIONS ARE TO FINISHED GRADE UNLESS OTHERWISE NOTED.
- 8. ALL STORM PIPES SHALL BE CLEANED BEFORE FINAL ACCEPTANCE.
- 9. CONTRACTOR TO CLEAN EXISTING STORM CATCH BASINS. REMOVE EXISTING LIQUIDS AND ANY ACCUMULATED SEDIMENT; DISPOSE OF AT AN APPROVED OFFSITE LOCATION AND PROVIDE COUNTY INSPECTOR WITH A COPY OF THE BILL OF LADING.
- 10. MATERIALS FOR THE STORM DRAINAGE SYSTEM SHALL BE IN ACCORDANCE WITH THE 2021 CITY OF TACOMA STORMWATER MANAGEMENT MANUAL.
- 11. ALL CATCH BASINS, INLETS, ETC SHALL BE MARKED WITH THE APPROVED COT CURB MARKERS / STENCILS. STENCILS ARE AVAILABLE FOR BOTH PRIVATE AND PUBLIC PROJECTS AS NEEDED.

| | STORM STRU | CTURE TABLE |
|-----------|--|--|
| | STRUCTURE NAME | STRUCTURE DETAILS |
| | FDCO 01 CO N 694944.64 E 1147237.65 | RIM = 262.20 IE = 258.44 (6" N) IE = 258.44 (6" S) IE = 261.00 (4" NE) IE = 261.00 (4" NW) |
| 3 C3.3 | MW INLET Null Structure N 694926.95 E 1147289.53 | IE = 259.21 (8" E) |
| 3 C3.3 | MW OUTLET Null Structure N 694927.13 E 1147282.53 | IE = 255.81 (8" W) |
| | RDCO #1 CO N 694987.35 E 1147139.55 | RIM = 263.96 IE = 262.25 (6" E) |
| | RDCO #2 CO N 694985.95 E 1147185.61 | RIM = 264.36 IE = 261.79 (6" W) IE = 261.79 (6" E) |
| | RDCO #3 CO N 694984.33 E 1147239.08 | RIM = 264.32 IE = 261.26 (6" W) IE = 261.26 (6" E) |
| | RDCO #4 CO N 694983.15 E 1147277.73 | RIM = 263.95 IE = 260.87 (6" W) IE = 260.87 (6" S) |
| | RDCO #5 CO N 694949.84 E 1147276.72 | RIM = 264.23 IE = 260.54 (6" N) IE = 260.54 (6" W) |
| | RDCO #6 CO N 694950.02 E 1147237.81 | RIM = 264.27 IE = 260.00 (6" S) |
| | SDCB 01 | DIM - 262 75 |

TYPE 1

N 694910.21

E 1147139.69

SITE AND BUILDING DIVISION


RIM = 263.75

IE = 261.08 (8" E)

| STORM STRU | CTURE TABLE |
|--|--|
| STRUCTURE NAME | STRUCTURE DETAILS |
| SDCB 02 TYPE 1 N 694902.33 E 1147287.79 | RIM = 262.81 IE = 260.34 (8" NE) IE = 260.34 (8" W) |
| SDCB 03 TYPE 1 N 694947.55 E 1147313.18 | RIM = 262.06 IE = 259.39 (8" SW) |
| SDCB 04 48" TYPE 2 N 694924.38 E 1147299.67 | RIM = 262.89 IE = 259.26 (8" W) IE = 259.26 (8" NE) IE = 259.26 (8" SW) |
| SDCB 05 48" TYPE 2 N 694934.52 E 1147237.39 | RIM = 264.04 IE = 255.50 (8" E) IE = 255.50 (6" E) IE = 255.50 (6" N) |
| | |






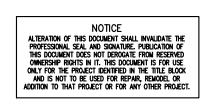



| Tacoma | | |
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| | NO | · |

| | | | | | FINAL CONSTRUCTION | DATE | SCALE |
|---|----|----------|------|------|-----------------------|--------------|-------------------------------|
| ļ | | | | | CHECKED | 10.5.2023 | N/A |
| 4 | | | | | | DESIGNED | CHECKED |
| | | | | | BY | DJH | DJH |
| | | | | | DATE | DRAWN | PROJECT NAME |
| | | | | | | DJH | TACOMA SUBARU MOD FACILITY |
| l | | | | | FIELD BOOKS | DRAWING NAME | NG AND |
| | NO | REVISION | DATE | APPD | | | GE PLAN |
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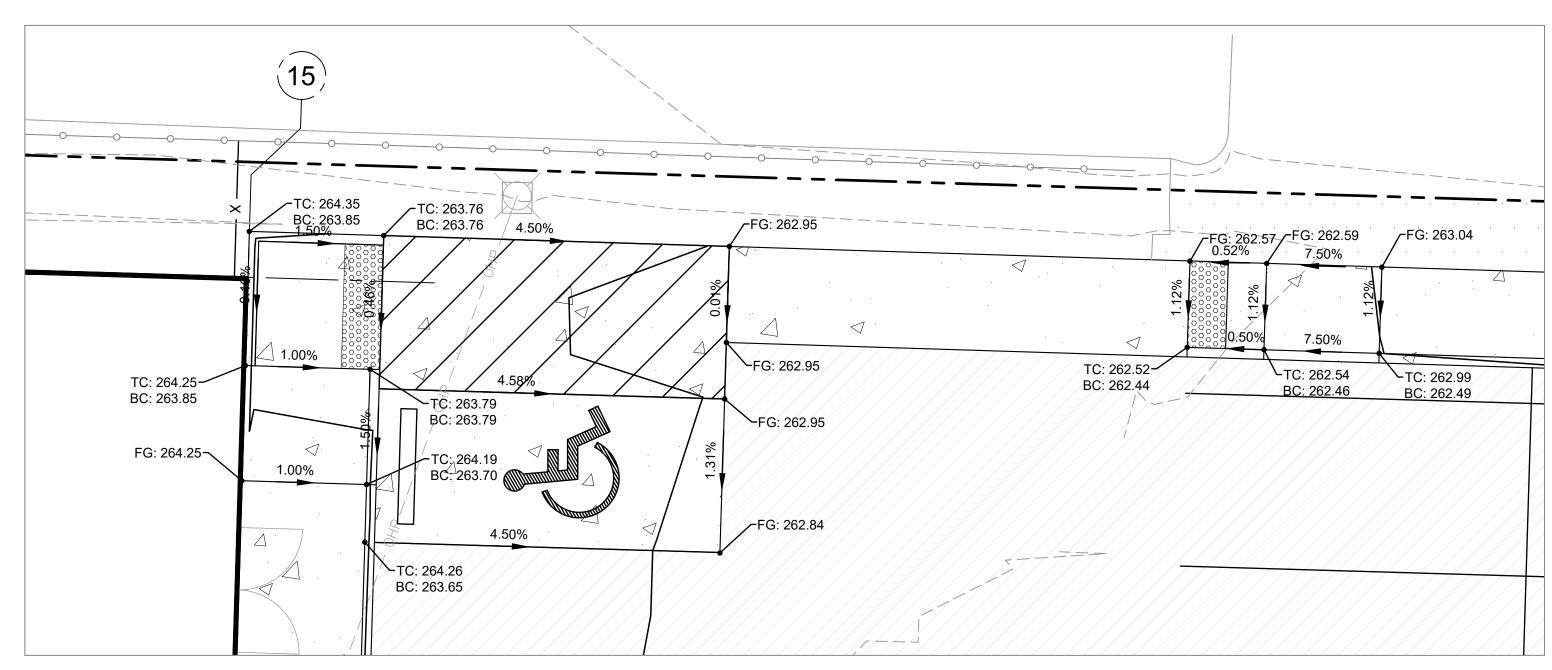
> TACOMA SUBARU MOD FACILITY 3812 SOUTH TACOMA WAY, TACOMA, WA 98409 SITE DEVELOPMENT PERMIT SET

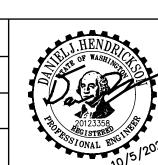SDEV23-0202 C3.0


7 of 12

GRAPHIC SCALE

1" = 20 FEET



ADA RAMPS AND PARKING BLOW UP

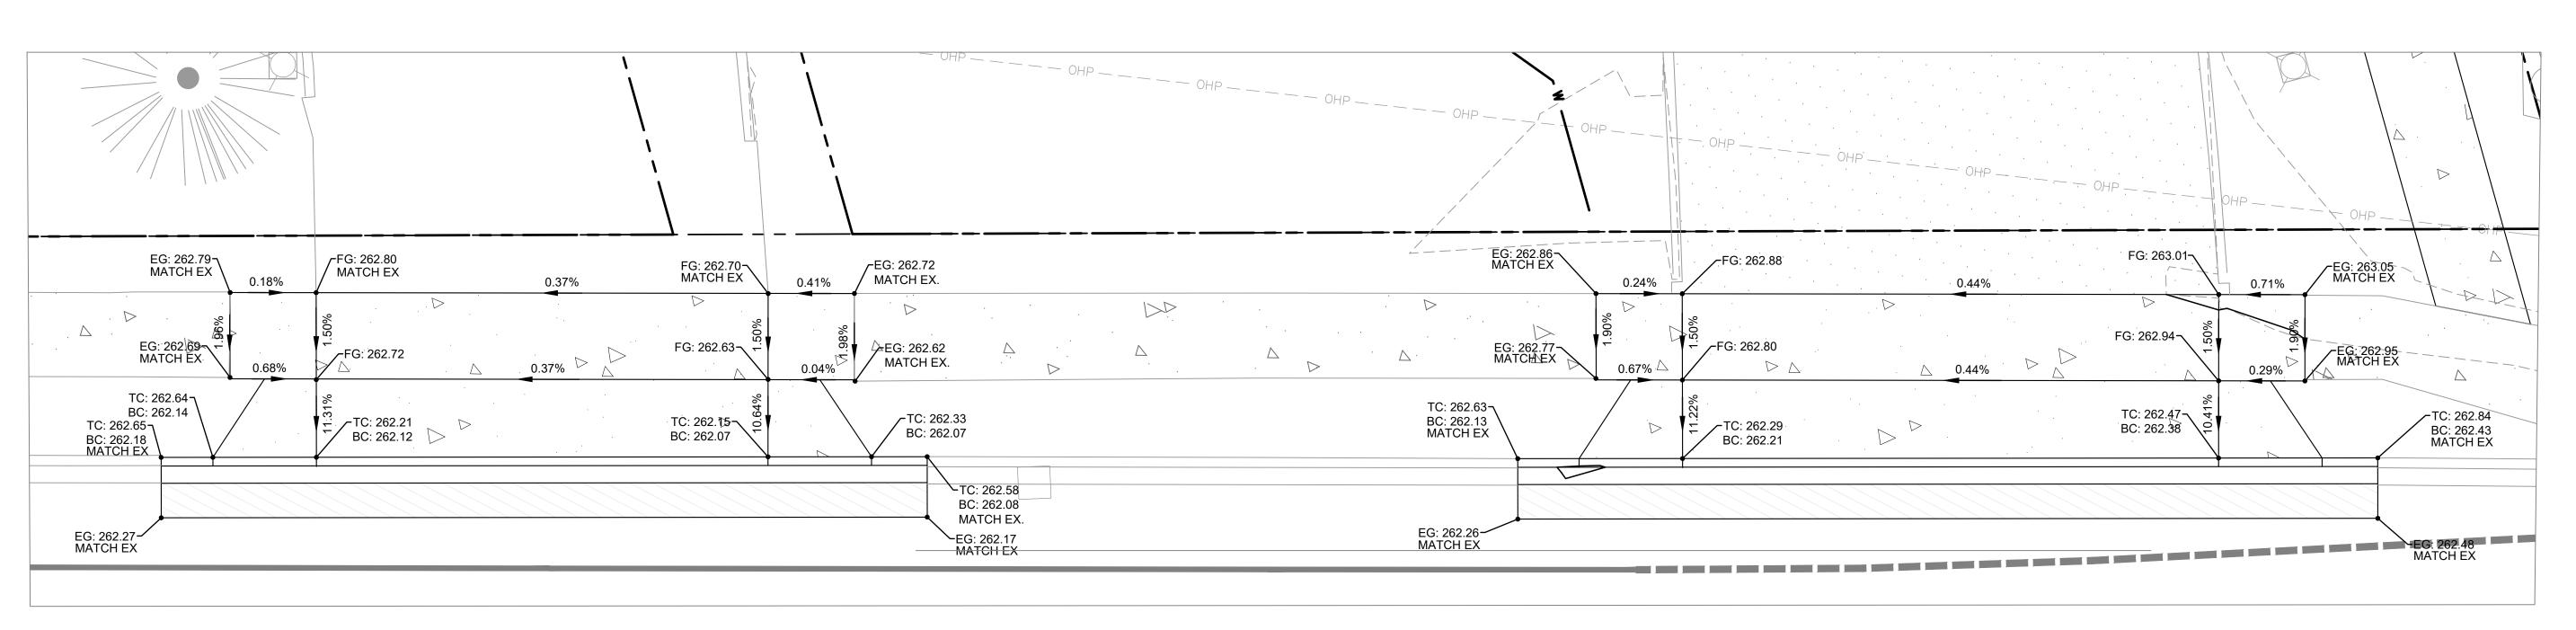


DRIVEWAY BLOW UPS
SCALE: 1" = 5'




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6909 FORD DR NW, GIG HARBOR, WA 98335 TEL: 253.514.2413



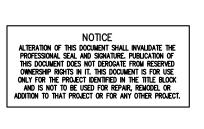

| | | | | | FINAL CONSTRUCTION | DATE | SCALE |
|--------|----|----------|------|------|-----------------------|--------------|-------------------------------|
| 4 11 | | | | | CHECKED | 10.5.2023 | N/A |
| 14.6 | | | | | | DESIGNED | CHECKED |
| - 14 | | | | | BY | DJH | DJH |
| أعمنته | | | | | DATE | DRAWN | PROJECT NAME |
| | | | | | BATE | DJH | TACOMA SUBARU MOD FACILITY |
| ma | | | | | FIELD BOOKS | DRAWING NAME | BLOW UPS |
| | NO | REVISION | DATE | APPD | | GRADING | BLOW OF 3 |

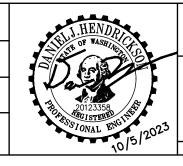


CITY OF TACOMA DEPARTMENT OF PUBLIC WORKS


TACOMA SUBARU MOD FACILITY 3812 SOUTH TACOMA WAY, TACOMA, WA 98409 SITE DEVELOPMENT PERMIT SET

SDEV23-0202

C3.1

8 of 12

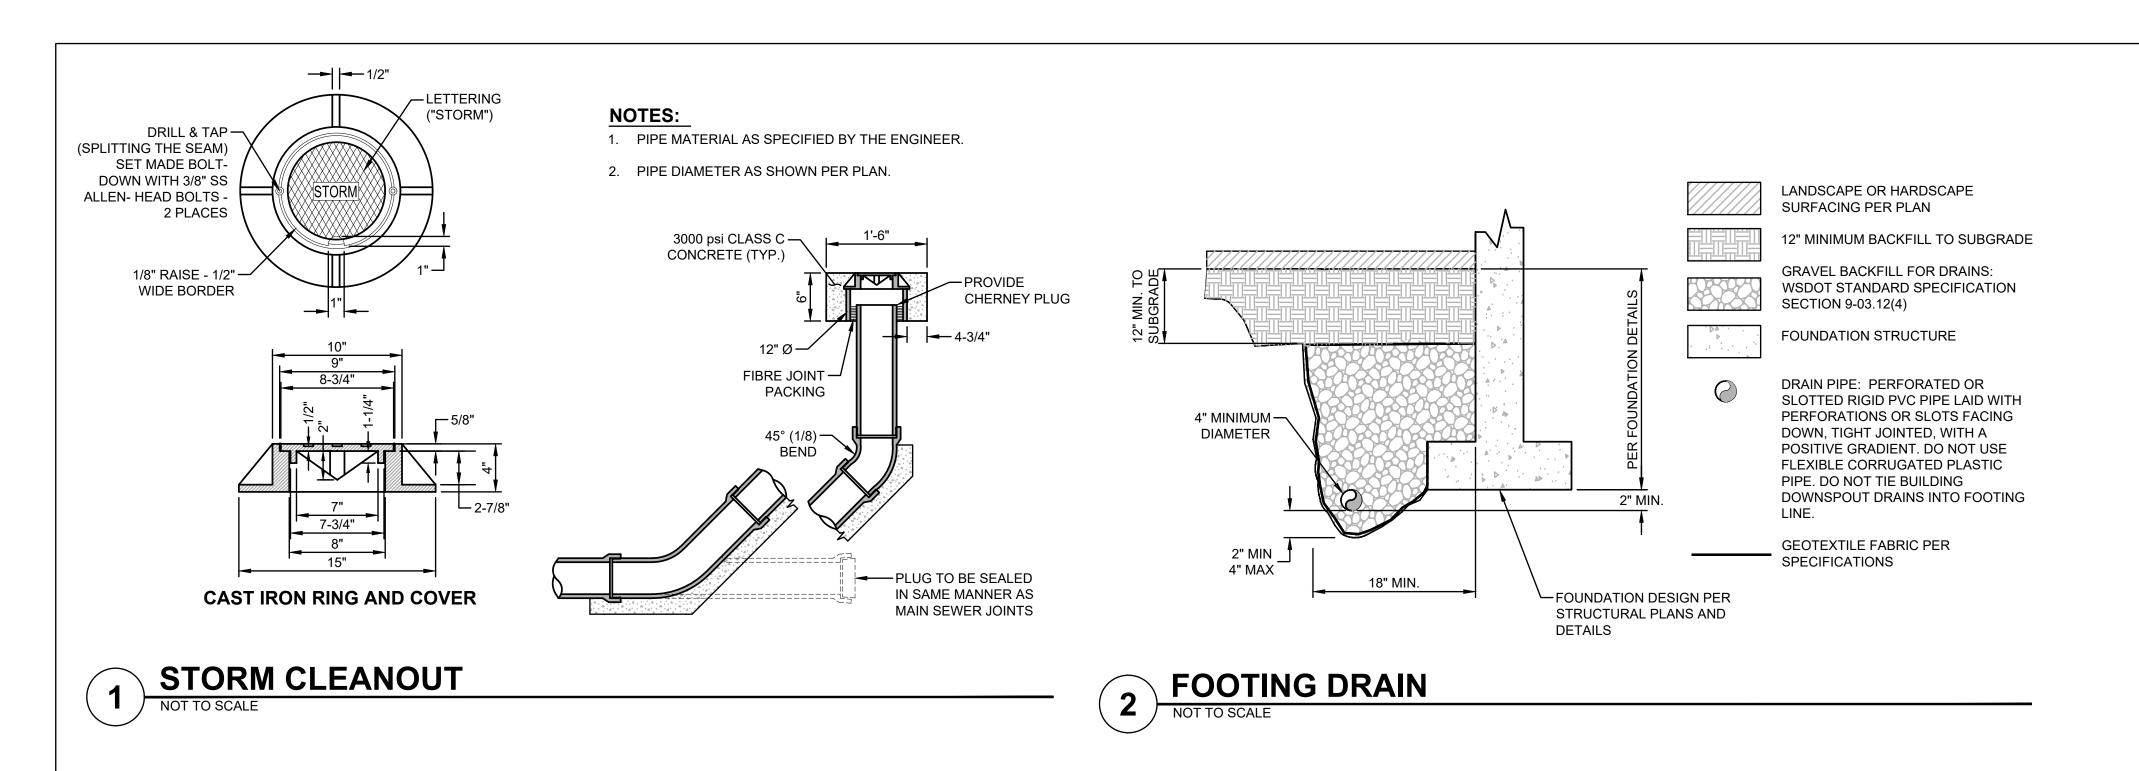


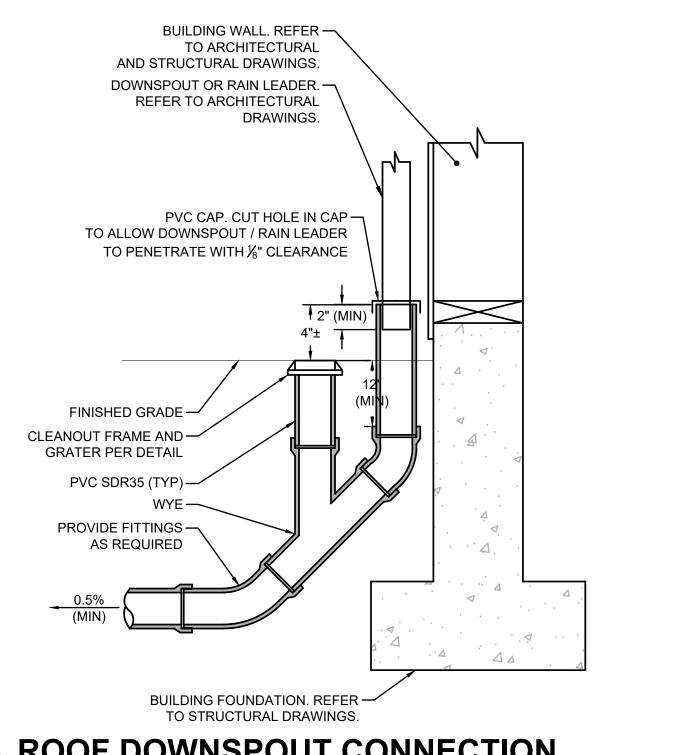



ROOF DOWNSPOUT CONNECTION

INFILTRATION TRENCH NOTES

- RUBBER GASKET OR GROUTING OF THE JOINTS FOR PERFORATED PIPE RUNS WILL NOT BE REQUIRED.
- WASHED DRAIN ROCK PER COT BMP 720.
- 3. ALL GEOTEXTILES SHALL CONFORM WITH COT BMP 720.

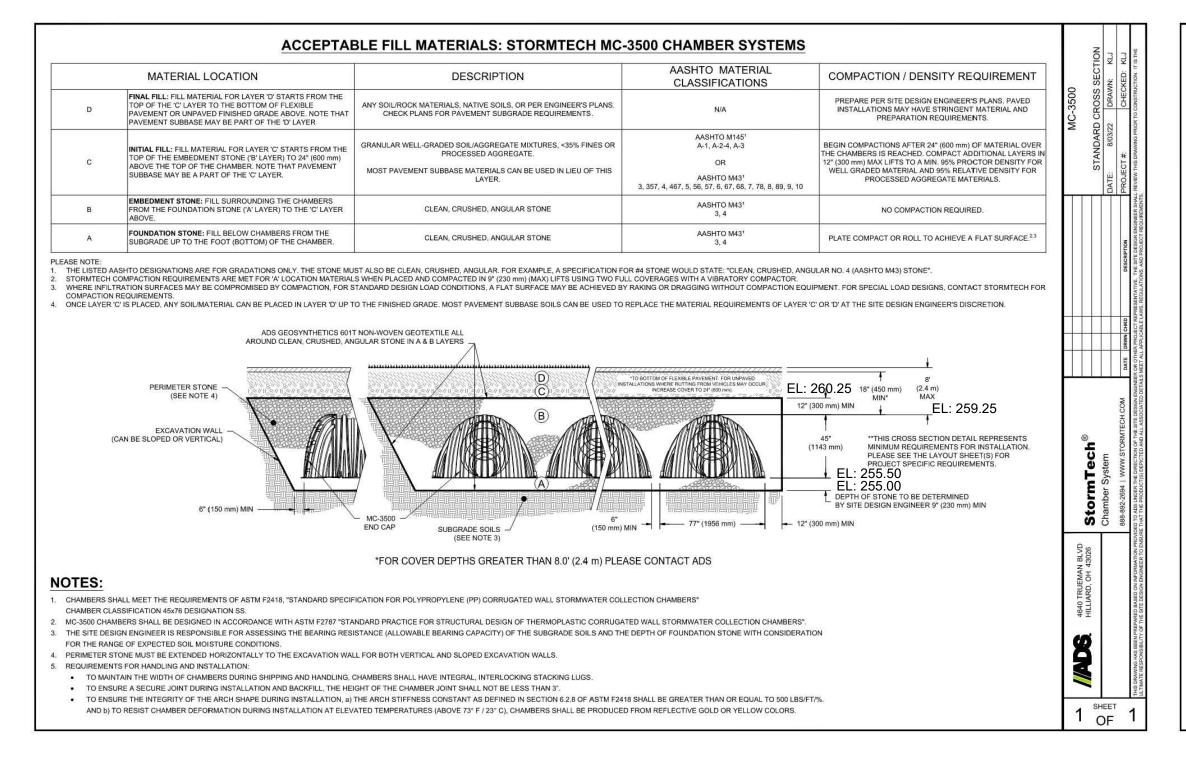

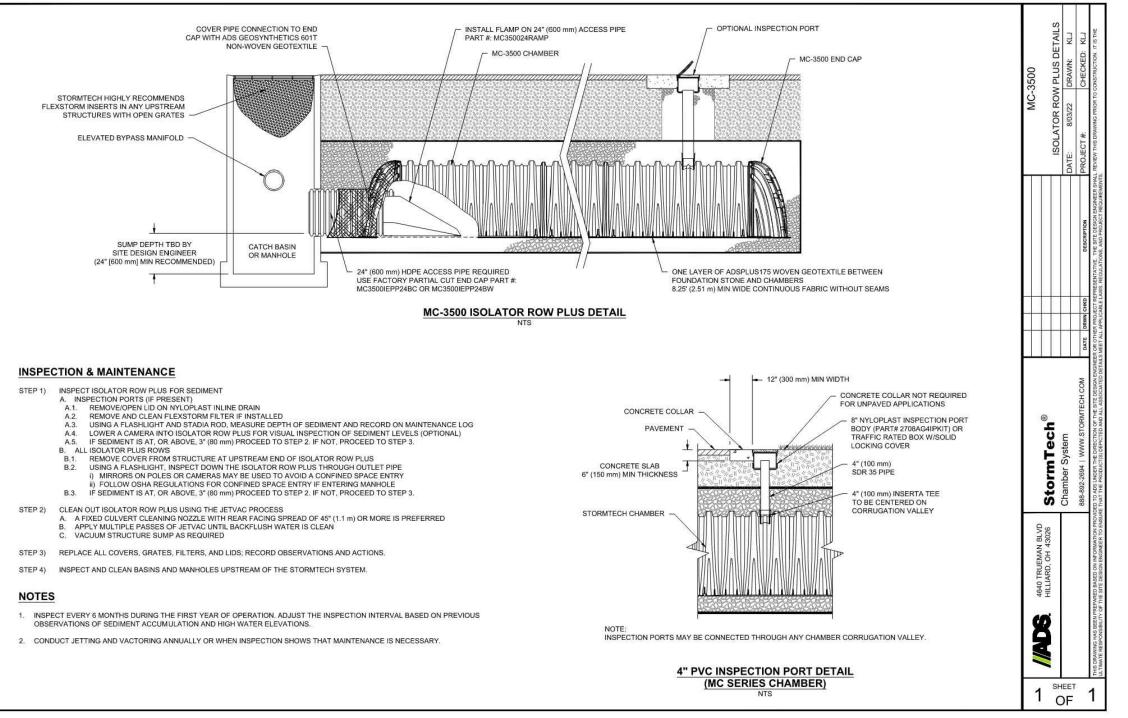

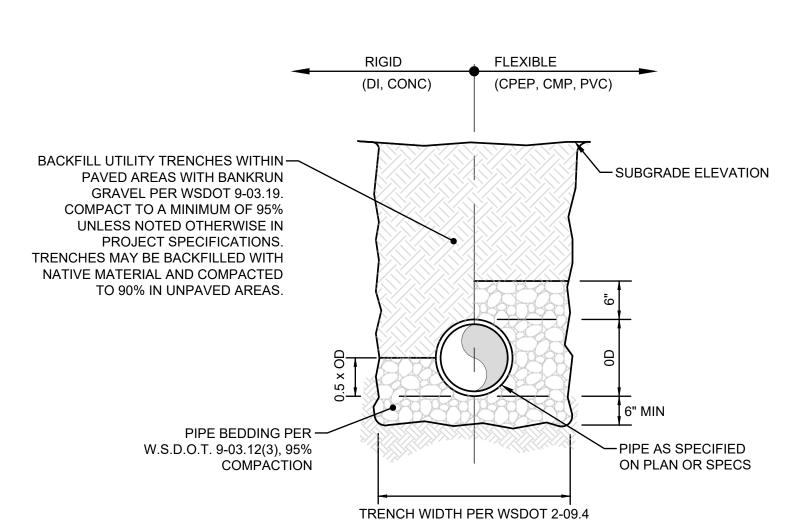










HENDRICKSON ENGINEERING 6909 FORD DR NW, GIG HARBOR, WA 98335 TEL: 253.514.2413

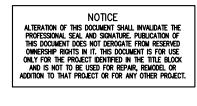



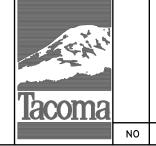

| N | ٥l | REVISION | DATE | APPD | | | ETAILS |
|---|----|----------|------|------|-----------------------|--------------|-------------------------------|
| 1 | | | | | FIELD BOOKS | DRAWING NAME | GE NOTES |
| | | | | | DATE | DJH | TACOMA SUBARU MOD FACILITY |
| | | | | | DATE | DRAWN | PROJECT NAME |
| ` | | | | | BY | DJH | DJH |
| 1 | | | | | | DESIGNED | CHECKED |
| | | | | | CHECKED | 10.5.2023 | N/A |
| | | | | | FINAL CONSTRUCTION | DATE | SCALE |

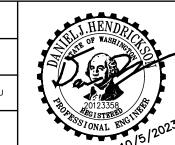



DEPARTMENT OF PUBLIC WORKS

TACOMA SUBARU MOD FACILITY 3812 SOUTH TACOMA WAY, TACOMA, WA 98409 SITE DEVELOPMENT PERMIT SET


CITY OF TACOMA

SDEV23-0202 C3.2

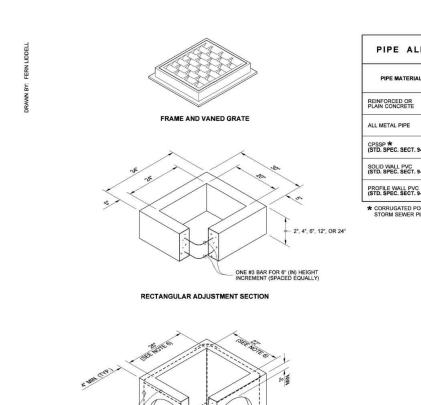

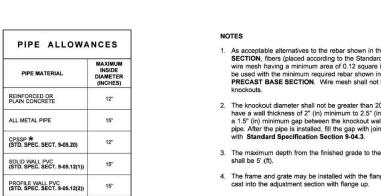

ALTERNATIVE PRECAST BASE SECTION

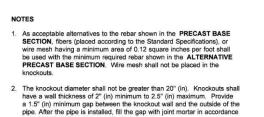



- The knockout diameter shall not be greater than 20" (in). Knockouts shall have a wall thickness of 2" (in) minimum to 2.5" (in) maximum. Provide a 1.5" (in) minimum gap between the knockout wall and the outside of the pipe. After the pipe is installed, fill the gap with joint mortar in accordance with Standard Specification Section 9-04.3. 3. The maximum depth from the finished grade to the lowest pipe invert
- 6. The opening shall be measured at the top of the Precast Base Section.

7. All pickup holes shall be grouted full after the basin has been placed.





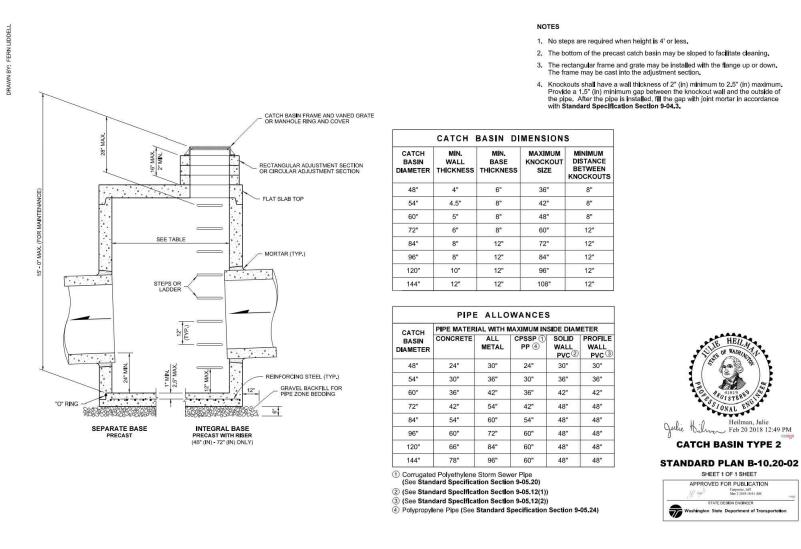

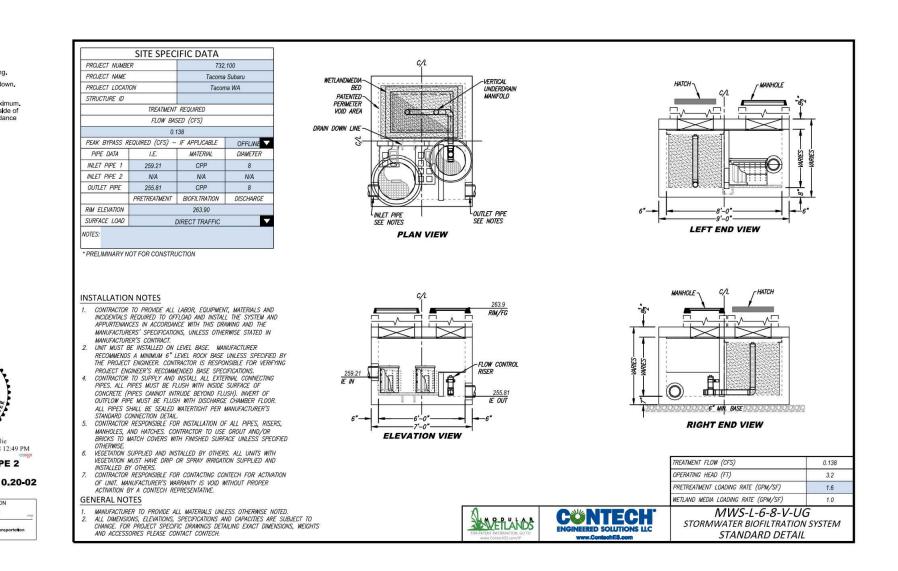


MODULAR WETLAND




PRECAST BASE SECTION



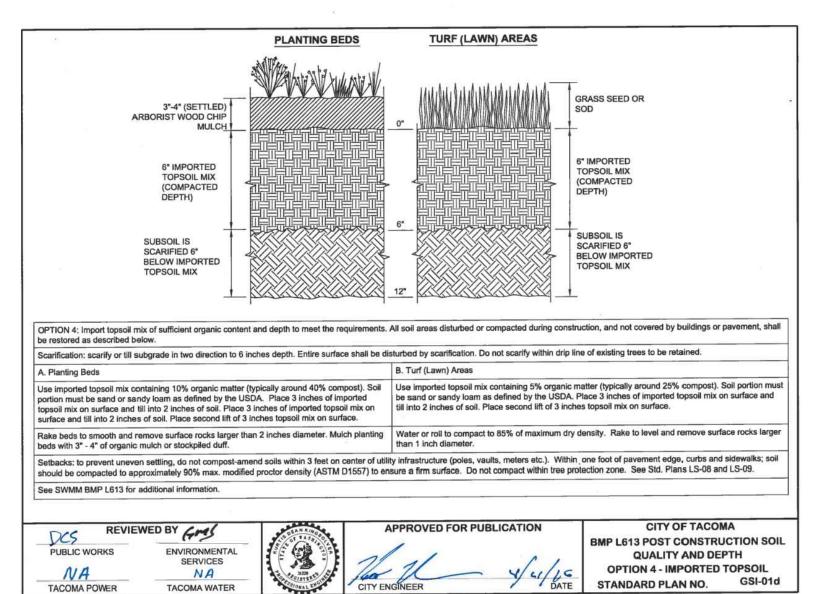


#3 BAR EACH CORNER _ 18" (IN) MIN.

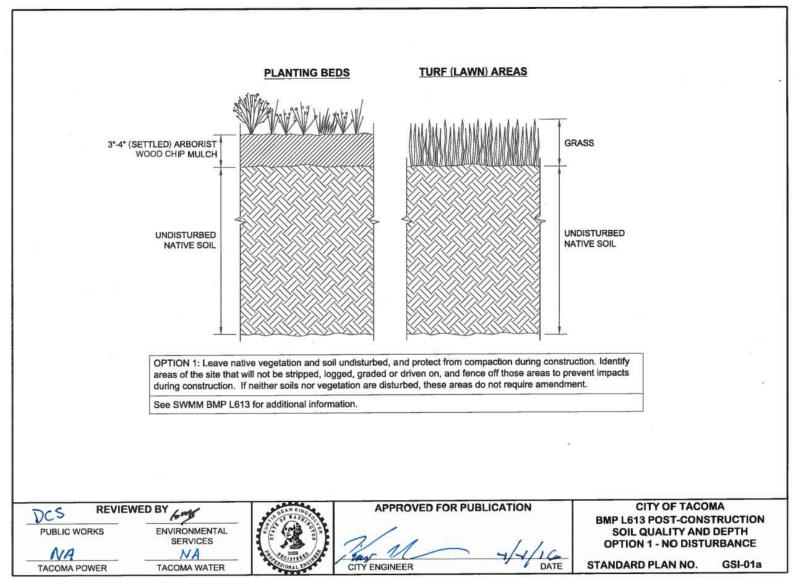








HENDRICKSON ENGINEERING 6909 FORD DR NW, GIG HARBOR, WA 98335 TEL: 253.514.2413

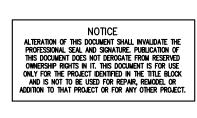



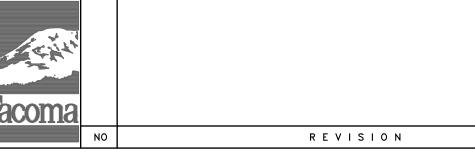

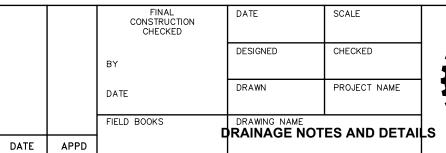


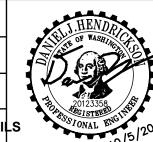


CITY OF TACOMA DEPARTMENT OF PUBLIC WORKS TACOMA SUBARU MOD FACILITY

3812 SOUTH TACOMA WAY, TACOMA, WA 98409 SITE DEVELOPMENT PERMIT SET

C3.3

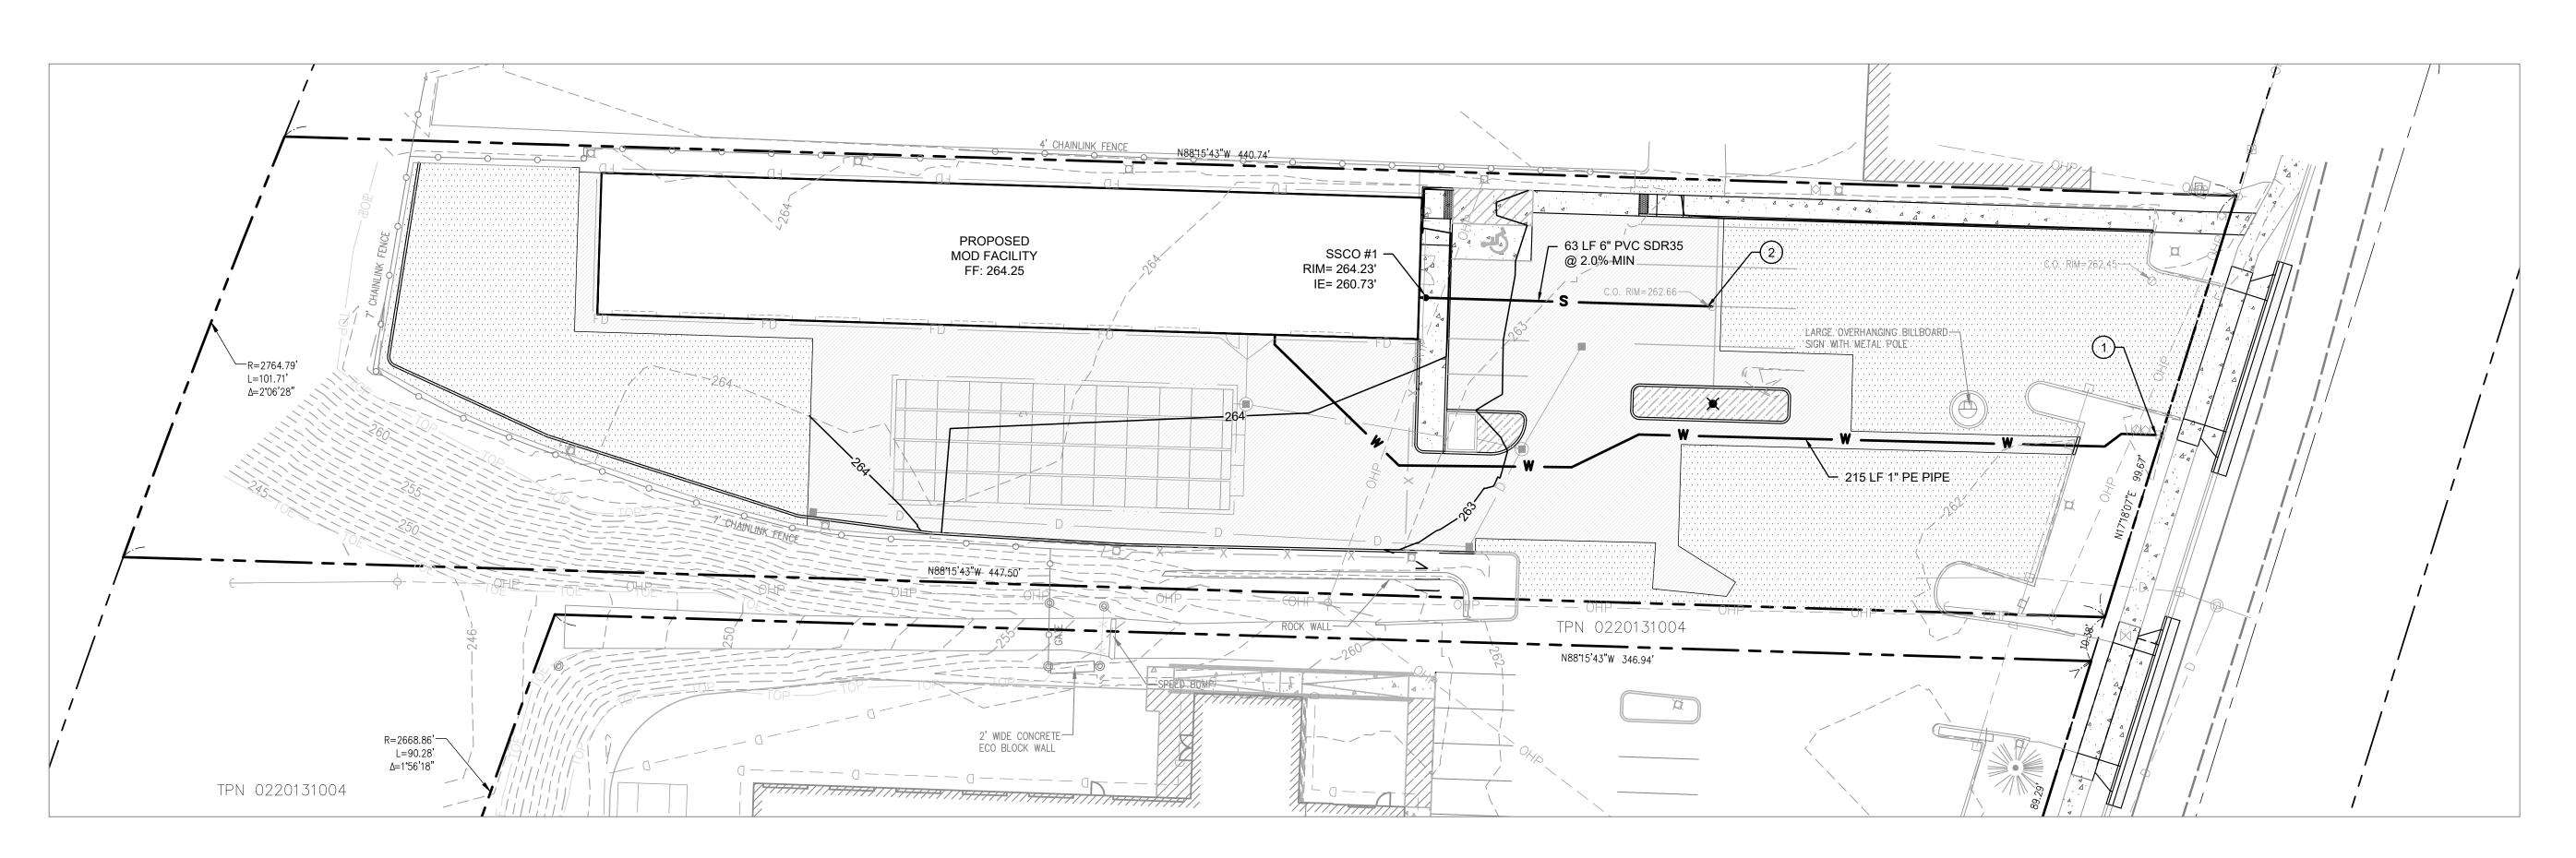

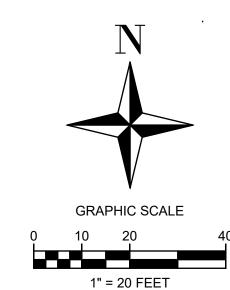

LEGEND

EXISTING LOT LINE PROPERTY SETBACK EASEMENT LINE **EXISTING MINOR CONTOUR** ----XXX-----EXISTING MAJOR CONTOUR — —XXX- — -PROPOSED MINOR CONTOUR ——XXX—— PROPOSED MAJOR CONTOUR ——XXX—— SANITARY SEWER CLEANOUT PROPOSED SEWER PIPE $\frac{2}{C4.1}$ PROPOSED WATER LINE

UTILITY NOTE

1. SURFACE UTILITY FACILITIES ARE SHOWN HEREON PER FIELD LOCATED VISIBLE EVIDENCE. THERE MAY BE UTILITIES THAT EXIST ON THIS SITE OTHER THAN THOSE GRAPHICALLY DEPICTED HEREON.

2. UNDERGROUND (BURIED) UTILITIES SHOWN HEREON ARE BASED ON COMBINATIONS OF VISIBLE SURFACE EVIDENCE, UTILITY LOCATOR MARKINGS AND RECORD DATA (SUCH AS AS-BUILT OR UTILITY DESIGN DRAWINGS). ALL UNDERGROUND UTILITIES SHOWN HEREON ARE APPROXIMATE AND, IN SOME CASES, ARE SHOWN AS STRAIGHT LINES BETWEEN FIELD LOCATED SURFACE UTILITY FACILITIES. UNDERGROUND UTILITIES MAY HAVE BENDS, CURVES OR CONNECTIONS WHICH ARE NOT SHOWN.

3. ALTHOUGH LOCATIONS OF UNDERGROUND UTILITIES BASED ON UTILITY LOCATOR MARKINGS AND RECORD DATA (SUCH AS AS-BUILT OR UTILITY DESIGN DRAWINGS) ARE DEEMED RELIABLE, HENDRICKSON ENGINEERING PLLC ASSUMES NO LIABILITY FOR THE ACCURACY OF SAID DATA.

4. CALL 1-800-424-5555 BEFORE ANY CONSTRUCTION.

5. ALL PROPOSED WORK TO BE COMPLETED WITHIN THE CITY RIGHT OF WAY SHALL REQUIRE A CITY OF TACOMA ROW PERMIT. THIS PERMIT SHALL BE OBTAINED UNDER A SEPARATE APPLICATION.

KEY NOTES

- EXISTING WATER SERVICE CONNECTION. CONTRACTOR TO FIELD VERIFY EXISTING WATER LINE SIZE AND LOCATION. EXISTING WATER \bigcup LINE MAY BE USED IF IT MEETS LOCAL STANDARDS AND IS ADEQUATE
- SIZE TO SERVE THE PROPOSED BUILDING CONNECT TO EXISTING SEWER CLEANOUT. EXISTING SANITARY SIDE SEWER BASED UPON CITY SEWER CARD INFORMATION. CONTRACTOR SHALL FIELD VERIFY EXISTING LOCATION AND DEPTH. IT IS ASSUMED
- THAT A GRAVITY CONNECTION TO THIS LOCATION IS FEASIBLE. ン CONTRACTOR TO FIELD VERIFY EXISTING INVERT ELEVATION. IF GRAVITY CONNECTION IS NOT FEASIBLE A GRINDER PUMP MAY BE NEEDED. CONTACT ENGINEER IF DEPTH FOR GRAVITY SEWER IS NOT FEASIBLE.

SEWER NOTES

- 1. TWO (2.0') FEET MINIMUM HORIZONTAL SEPARATION IS REQUIRED FOR SIDE SEWER STUBS ON OPPOSITE SIDES OF THE SEWER MAIN (OTHERWISE 10' MIN. SEPARATION IS REQUIRED).
- 2. TWO (2.0') FEET MINIMUM HORIZONTAL SEPARATION IS REQUIRED FOR ALL PRESSURE SIDE SEWER STUBS
- 3. CATCH BASINS SHALL BE FIELD VERIFIED BY THE CONTRACTOR.
- 4. FIVE (5) FEET MINIMUM HORIZONTAL SEPARATION IS REQUIRED BETWEEN SIDE SEWER STUBS
- 5. GRAVITY SIDE SEWER CONNECTION AND SERVICE STUBS PER
- 6. CONTACT UNDERGROUND LOCATE ("ONE-CALL") SERVICE AT (800) 424-5555 PRIOR TO ANY

CONSTRUCTION NOTES

- 1. PEA GRAVEL BEDDING WILL BE PLACED 4" BELOW AND 6" ABOVE PIPE. NO OTHER BEDDING MATERIAL IS ACCEPTABLE.
- 2. HYDROSTATIC TESTING WILL BE DONE IN ACCORDANCE WITH THE CITY UTILITY SANITARY SEWER SPECIFICATIONS, LATEST EDITION.
- 3. INSPECTION SHALL INCLUDE THE GRAVITY SEWER IN ACCORDANCE WITH THE APPROVED PLANS. NO DEVIATION FROM THE APPROVED PLANS WILL BE ALLOWED WITHOUT PRIOR WRITTEN APPROVAL OF THE UTILITIES DEPARTMENT ENGINEERING SECTION.
- 4. THE SEWER LINES SHALL REMAIN UNDER THE OWNERSHIP OF THE PROPERTY OWNER WHO SHALL BE RESPONSIBLE FOR THEIR OPERATION AND MAINTENANCE.
- 5. ALL UTILITIES CROSSING SEWER LINES MUST HAVE PROPER VERTICAL CLEARANCE. THE STANDARD VERTICAL SEPARATION FOR WATER LINES IS 3 FEET ABOVE THE SEWER LINE AND 1.5 FEET FOR ALL OTHER UTILITIES. CONCRETE ENCASEMENT OF SEWER LINES WILL BE ALLOWED FOR WATER MAINS CROSSING AT LESS THAN 3 FEET BUT NO CLOSER THAN 1.5 FEET. THE SANITARY SEWER ENCASEMENT SHALL BE 10 FEET ON EACH SIDE OF THE CROSSING.
- 6. PARALLEL SEWER WATER LINES MUST HAVE 10 FEET OF HORIZONTAL SEPARATION.

WATER NOTE

UNLESS OTHERWISE SPECIFIED, MATERIALS AND WORKMANSHIP FOR THE WATER SYSTEM AND THEIR INSTALLATION SHALL BE IN ACCORDANCE WITH THE REQUIREMENTS OF THE LATEST ADOPTED EDITION OF THE WASHINGTON STATE DEPARTMENT OF TRANSPORTATION (WSDOT) STANDARD SPECIFICATIONS, DIVISION 7 AND REQUIREMENTS OF THE APPLICABLE PURVEYOR.

TOPOGRAPHIC NOTE

THE EXISTING CULTURAL AND TOPOGRAPHIC DATA SHOWN ON THESE DRAWINGS HAS BEEN PREPARED, IN PART, BASED UPON INFORMATION FURNISHED BY OTHERS. WHILE THIS INFORMATION IS BELIEVED TO BE RELIABLE, HENDRICKSON ENGINEERING PLLC CANNOT ENSURE ACCURACY AND THUS IS NOT RESPONSIBLE FOR THE ACCURACY OF THAT INFORMATION OR FOR ANY ERRORS OR OMISSIONS WHICH MAY HAVE BEEN INCORPORATED INTO THESE DRAWINGS AS A RESULT.

BASIS OF BEARING

HELD SOUTH 88°42'01" EAST BETWEEN CITY OF TACOMA CONTROL MONUMENTS #1220 AND #1033

HORIZONTAL DATUM

WASHINGTON STATE PLAN COORDINATE SYSTEM, SOUTH ZONE (NAD 83/91)

BASED ON TIES CITY OFTACOMA MONUMENTS #34, 1033, 1219 AND 1220.

COT MONUMENT #1220

N 695117.01 E 1147556.43

> FOUND 3" BRASS DISK W/PUNCH ON SURFACE AT INTX. OF S. 38TH ST. AND UNION AVE.

> > SITE AND BUILDING DIVISION

VERTICAL DATUM

CITY OF TACOMA NGVD 29


BENCHMARK 3760

DESC "X" ON SE BOLT OF STREET LIGHT POLE AT THE SE CORNER OF THE INTERSECTION OF S 38TH STREET AND SOUTH TACOMA WAY. ELEV: 263.28'



HENDRICKSON ENGINEERING


6909 FORD DR NW, GIG HARBOR, WA 98335 TEL: 253.514.2413

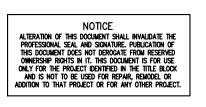





| | NO | REVISION | DATE | APPD | | | |
|---|----|----------|------|------|--------------|------------------------|---|
| | | | | | FIELD BOOKS | DRAWING NAME WATER AND | SEWER PLA |
| | | | | | DATE | DRAWN DJH | PROJECT NAME TACOMA SUBARU MOD FACILITY |
| | | | | | BY | DJH | DJH |
| Ì | | | | | | DESIGNED | CHECKED |
| | | | | | CHECKED | 10.5.2023 | N/A |
| | | | | | CONSTRUCTION | DATE | SCALE |

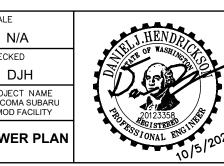


CITY OF TACOMA DEPARTMENT OF PUBLIC WORKS


TACOMA SUBARU MOD FACILITY 3812 SOUTH TACOMA WAY, TACOMA, WA 98409 SITE DEVELOPMENT PERMIT SET

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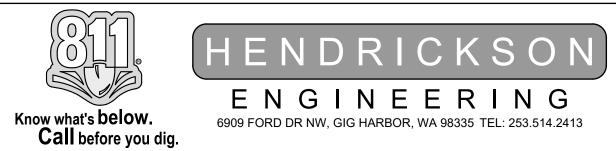
11 of 12




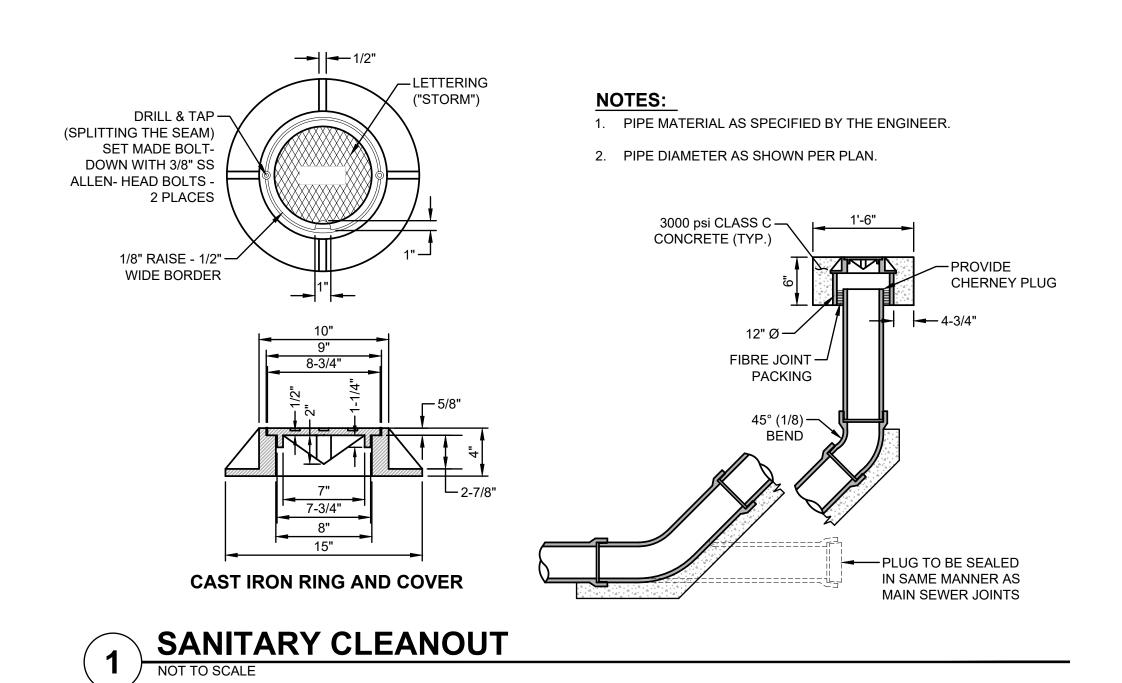

PIPE BEDDING AND BACKFILL

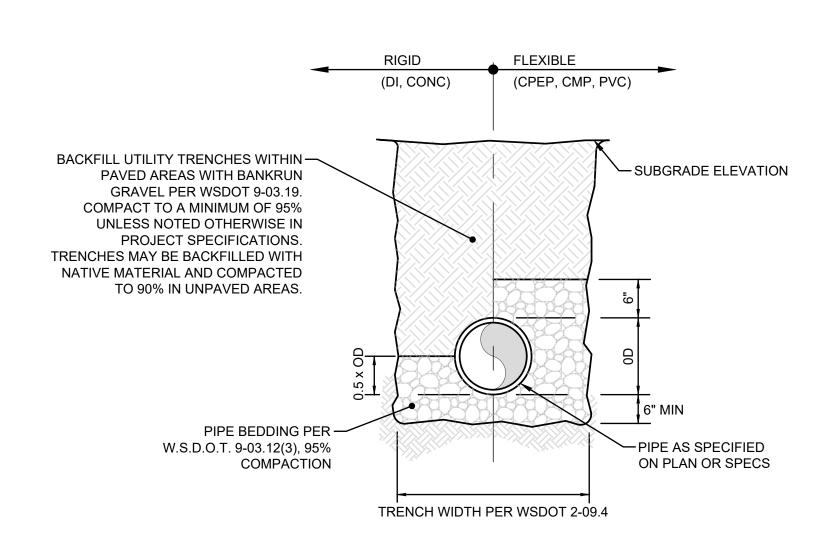
NOT TO SCALE



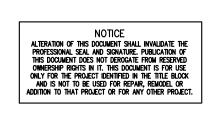





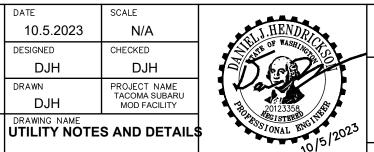

10.5.2023

DJH

DJH

DATE

N/A

DJH

PROJECT NAME TACOMA SUBARU MOD FACILITY

DEPARTMENT OF PUBLIC WORKS TACOMA SUBARU MOD FACILITY 3812 SOUTH TACOMA WAY, TACOMA, WA 98409

SITE DEVELOPMENT PERMIT SET

CITY OF TACOMA

SDEV23-0202 C4.1

12 of 12

DATE: October 5, 2023 FILENAME: C:\Users\dhend\Hendrickson Const Co Dropbox\Daniel Hendrickson\Hendrickson Engineering\Projects\2022\2220033 (Tacoma Subaru Addition)\CAD\2220033-SH-UTL.dwg