

VICINITY MAP

GENERAL NOTES

- ALL WORK SHALL CONFORM TO REQUIREMENTS OF THE 2018 INTERNATIONAL BUILDING CODES (IBC), 2018 INTERNATIONAL EXISTING BUILDING CODE (IEBC), 2018 INTERNATIONAL FIRE CODE (IFC), 2018 WASHINGTON STATE ENERGY CODE (WSEC), STATE BUILDING CODE AND ALL OTHER APPLICABLE CODES AS ADOPTED BY THE AUTHORITY HAVING JURISDICTION.
- 2. THE GENERAL CONTRACTOR IS RESPONSIBLE FOR THE COORDINATION OF ALL BUILDING SYSTEM DESIGN AND INSTALLATION INCLUDING SITE DESIGN, LANDSCAPE DESIGN, CIVIL ENGINEERING, STRUCTURAL ENGINEERING, INTERIOR DESIGN AND MATERIAL SELECTIONS.
- 3 IN NO CASE SHALL THE DRAWINGS BE SCALED FOR DIMENSIONS. CONTRACTOR SHALL VERIFY ALL CONDITIONS AND DIMENSIONS IN THE FIELD PRIOR TO PROCEEDING WITH SUBSEQUENT WORK, NOTIFY THE ARCHITECT OF ANY DISCREPANCIES WHICH REQUIRE PHYSICAL CHANGE PRIOR TO BEGINNING SAID WORK.
- 4. CONTRACTOR IS RESPONSIBLE TO OBTAIN ALL PERMITS INCLUDING APPLICABLE HEALTH AND SITE PERMITS OTHER THAN THE BUILDING PERMIT AS MAY BE REQUIRED FOR COMPLETION OF THIS PROJECT. FEES FOR THESE PERMITS SHALL BE REIMBURSED BY THE OWNER. 5. CONTRACTOR SHALL COORDINATE SITE WORK: PLUMBING, DRAINAGE, ELECTRICAL, TELEPHONE, AND OTHER UTILITIES AS REQUIRED FOR COMPLETE OPERATING
- 6. ALL FRAMING MEMBERS SHALL BE SO ARRANGED AND SPACED AS TO PERMIT INSTALLATION OF PIPE CONDUITS AND DUCTWORK WITH A MINIMUM OF CUTTING.
- CONTRACTOR SHALL PROVIDE AND INSTALL ALL STIFFENERS, BRACES, BACK-UP PLATES, AND SUPPORTING BRACKETS REQUIRED FOR THE INSTALLATION OF ALL WALL MOUNTED OR SUSPENDED STAIR RAILINGS. CASEWORK, TOILET ROOM ACCESSORIES, MECHANICAL, ELECTRICAL, PLUMBING, OR MISC. EQUIPMENT. DUCTS PENETRATING STUD WALLS OR SHAFT WALLS SHALL BE PROVIDED NECESSARY FRAMES, BRACING AND SEALANT AROUND OPENING(S).
- 8. ALL EQUIPMENT RECESSED INTO FIRE RATED WALLS SHALL BE PROVIDED WITH BACKING BEHIND TO MAINTAIN THE FIRE RATING OF THAT WALL 9. FIRE DAMPERS OR DOORS SHALL BE PROVIDED WHERE AIR DUCTS PENETRATE FIRE RATED WALLS OR CEILINGS AS REQUIRED BY CODE.
- 10. SMOKE DAMPERS OR DOORS SHALL BE PROVIDED WHERE PENETRATING DRAFTSTOPS OR SMOKE PARTITIONS AS REQUIRED BY CODE. 11. ALL FIRE RATED ASSEMBLIES SHALL BE ICBO OR UL APPROVED AND PROVIDED AS INDICATED ON THE APPROVED DRAWINGS. ANY PENETRATIONS AT THE FIRE
- RESISTIVE ASSEMBLIES SHALL BE SEALED WITH UL APPROVED FIRE STOPPING. SUBMIT METHOD OF FIRE STOPPING TO BUILDING INSPECTOR FOR APPROVAL. 12. FIRE ALARM SYSTEMS SHALL BE "BIDDER/DESIGN". FURNISH AND INSTALL AN APPROVED FIRE ALARM WARNING SYSTEM. COORDINATE WITH OWNER, FIRE MARSHAL AND ELECTRICAL CONTRACTOR.
- 13. FURNISH AND INSTALL EMERGENCY LIGHTING. IN NO CASE SHALL THE LIGHTING LEVEL BE LESS THAN ONE FOOT-CANDLE AT FLOOR LEVEL IN ALL EXIT CORRIDORS AND STAIR SHAFTS. 14. ALL EXIT SIGNS SHALL HAVE 6" HIGH LETTERS IN ACCORDANCE WITH LOCAL CODES AND SHALL CONFORM TO IBC REQUIREMENTS, LUMINANCE ON SIGN SHALL BE 50
- LUX. ILLUMINATED EXIT SIGN TO HAVE RESERVE POWER. 15. ALL DOOR SIZES SHOWN ON THE DOOR SCHEDULE ARE OPENING SIZES, ALLOWANCE FOR THRESHOLDS, ETC., SHALL BE MADE PRIOR TO DOOR FABRICATION AND
- INSTALLATION. ALL DOORS AND FRAMES SHALL BE REINFORCED WHERE REQUIRED FOR CLOSERS, STOPS, HARDWARE, ETC. 16. DOORS IN RATED WALLS SHALL CONSIST OF SELF CLOSING, SELF LATCHING ASSEMBLIES WITH SMOKE AND DRAFT SEALS AT HEAD AND JAMB. DOOR ASSEMBLY RATINGS SHALL BE AS INDICATED ON THE DOOR SCHEDULE. HOLD OPEN DEVICES ON RATED ASSEMBLIES SHALL BE MAGNETICALLY OPERATED AND ACTIVATED BY SMOKE DETECTORS, PROVIDE COORDINATORS FOR PAIRS OF DOORS TO ALLOW FOR PROPER CLOSING SEQUENCE. 17. ALL EXTERIOR DOORS SHALL BE WEATHER STRIPPED AT JAMBS, HEAD AND SILL.
- 18. EXIT REQUIREMENTS: A) ALL LEGAL EXIT DOORS SHALL BE OPENABLE FROM THE INSIDE WITHOUT THE USE OF A KEY OR SPECIAL KNOWLEDGE OR EFFORT, OR SHALL HAVE LEGAL SIGNS POSTED READING. " THIS DOOR TO REMAIN UNLOCKED DURING BUSINESS HOURS."
- B) CONTRACTOR SHALL PROVIDE TEMPORARY EXIT SIGNS TO ASSURE A MEANS OF EGRESS DURING CONSTRUCTION, AS MAY BE NECESSARY C) DOORS EQUIPPED WITH PANIC HARDWARE SHALL BE OPENABLE WITH A MAXIMUM FORCE OF 15 LBS APPLIED IN THE DIRECTION OF EGRESS TO THE BAR. D) DOORS SHALL SWING IN A FULLY OPEN POSITION WITH AN OPENING FORCE NOT TO EXCEED 30 LBS. APPLIED TO THE LATCH SIDE, WITHIN AN ACCESSIBLE ROUTE OF TRAVEL, SUCH FORCE SHALL NOT EXCEED 8.5 LBS. FOR EXTERIOR DOORS AND 5 LBS. FOR INTERIOR DOORS APPLIED IN THE DIRECTION OF EGRESS TO THE
- 19. BARRIER FREE ACCESS REQUIREMENTS: ALL WORK REQUIRED TO COMPLY WITH BARRIER FREE REQUIREMENTS SHALL BE IN ACCORDANCE WITH WASHINGTON STATE REGULATIONS (WAC 51-50) AND ANSI A117,1-2009.
- 20. MECHANICAL SYSTEMS SHALL BE "BIDDER/DESIGN". VERIFY ALL REQUIREMENTS WITH OWNER AND/OR TENANT. COORDINATE OWNER PROVIDED EQUIPMENT. MECHANICAL SUBCONTRACTOR TO SUBMIT DRAWINGS AND CALCULATIONS FOR APPROVAL AND PERMITS. MECHANICAL SUBCONTRACTOR IS RESPONSIBLE FOR REQUIRED PERMIT FEES AND ALL MISC. FEES ASSOCIATED WITH SAID PERMIT(S).
- 21. ELECTRICAL SYSTEMS SHALL BE "BIDDER/DESIGN". VERIFY ALL REQUIREMENTS WITH OWNER AND/OR TENANT. COORDINATE OWNER PROVIDED EQUIPMENT. ELECTRICAL SUBCONTRACTOR TO SUBMIT DRAWINGS AND CALCULATIONS FOR APPROVAL AND PERMITS. ELECTRICAL SUBCONTRACTOR IS RESPONSIBLE FOR
- REQUIRED PERMIT FEES AND ALL MISC. FEES ASSOCIATED WITH SAID PERMITS. 22. CONTRACTORS SHALL YERIFY SIZES AND LOCATIONS OF ALL MECHANICAL EQUIPMENT PADS AND BASES, AS WELL AS POWER AND WATER OR DRAIN INSTALLATIONS
- WITH EQUIPMENT MANUFACTURERS BEFORE PROCEEDING WITH THE WORK. 23. PROVIDE FIRE EXTINGUISHERS PER FIRE MARSHALL.
- 24. THESE DOCUMENTS DO NOT INCLUDE THE NECESSARY COMPONENTS FOR CONSTRUCTION SAFETY. THE SAFETY AND CARE OF ADJACENT PROPERTY (OR SPACES) DURING CONSTRUCTION AND COMPLIANCE WITH STATE AND FEDERAL REGULATIONS REGARDING SAFETY SHALL BE RESPONSIBILITY OF THE CONTRACTOR.
- 25. COLORS AS SELECTED BY INTERIOR DESIGNER AND OWNER.

PROJECT NARRATIVE

THE PROPOSED PROJECT IS THE REMOVAL OF THREE EXISTING BUILDING STRUCTURES WITH THE DEVELOPMENT OF A NEW 5,941 SQUARE FOOT MODIFICATION FACILITY TO SUPPORT THE DIRECTLY ADJACENT TACOMA SUBARU DEALERSHIP. THE BUILDING WILL BE USED PRIMARILY FOR THE MODIFICATION OF PERSONAL VEHICLES - E.G. ADDING ACCESSORIES TRIMS. CUSTOM COMPONENTS. THE GENERAL SERVICING OF PERSONAL VEHICLES (OIL-CHANGES/MECHANICAL REPAIRS) WILL REMAIN AT THE EXISTING TACOMA SUBARU DEALERSHIP SERVICE FACILITIES. THIS PROJECT WAS PRELIMINARILY REVIEWED BY THE CITY OF TACOMA PERMIT PRE22-0206.

THE BUILDING IS TO BE SITED WITH THE FRONT FACADE (EAST ELEVATION FACING SOUTH TACOMA WAY) ALIGNED AND ORTHOGONAL WITH THE EXPRESS SERVICE BUILDING TO THE SOUTH. THIS WILL ALLOW FOR AN EXTENSION OF THE PEDESTRIAN WALK FROM THE EXPRESS SERVICE TO THE NEW MOD FACILITY. PARKING WILL BE LOCATED TO THE EAST OF THE BUILDING AND ACCESSED VIA THE EXISTING CURB CUT DRIVEWAYS ALONG SOUTH TACOMA WAY. THE BUILDING IS PROPOSED TO BE SITED WITHIN 6-FEET OF THE NORTH PROPERTY LINE IN ORDER TO MAXIMIZE VEHICLE MANEUVERABILITY ON THE SOUTH SIDE OF THE FACILITY. THE WESTERN-HALF OF THE PARCEL IS PROPOSED TO BE FENCED FOR SECURITY (WITH A SLIDING GATE RECESSED 45-FEET BACK FROM THE FRONT/EAST FACADE).

GIVEN THE STREET IMPROVEMENT CONSTRUCTION ALONG SOUTH TACOMA WAY BY THE CITY OF TACOMA IN 2015, NO ADDITIONAL STREET IMPROVEMENTS ARE PROPOSED. THE EXISTING MATURE FRONTAGE LANDSCAPING IT TO BE RETAINED TO MAINTAIN CONTINUITY WITH THE OTHER TACOMA SUBARU PROPERTIES TO THE SOUTH. NEW LANDSCAPING IS LIMITED TO THE NEW INTERIOR ISLANDS CREATED AS PART OF THIS PROJECT AS THE INDUSTRIAL ZONING DOES NOT REQUIRE PERIMETER LANDSCAPING (PLEASE SEE CIVIL ENGINEERING DRAWING C2.0). THE EXISTING POLE SIGN IN THE FRONT PARKING AREA IS TO REMAIN - WITH NEW SIGNAGE PROPOSED AS A WALL SIGN ON THE EAST FRONTAGE OF THE BUILDING (SIGNAGE TO BE UNDER A SEPARATE PERMIT).

PARKING CALCULATION:

THIS TYPE OF FACILITY IS NOT ADDRESSED IN SECTION 13.06.090 OF THE TACOMA MUNICIPAL CODE SINCE THE CUSTOMER'S PERSONAL VEHICLE WILL BE BROUGHT INTO A A BAY FOR CUSTOMIZING THUS PARKING FOR STAFF AT ONE STALL PER BAY SEEMED REASONABLE. PER JENNIFER KAMMERZELL (THEN INTERMIN DIVISION MANAGER WITH CITY OF TACOMA PUBLIC WORKS DEPARTMENT) EMAIL OF 9.19.2022, 12 PARKING STALLS WAS CONFIRMED AS THE MINIMUM REQUIURED (PLEASE SEE CALCULATION ON DRAWING A0.2 CODE ANALYSIS). 13 PARKING STALLS ARE PROPOSED WITH ONE BEING AN ACCESSIBLE VAN STALL.

SITE LIGHTING WILL UTILIZE THE EXISTING LIGHTING ON THE EAST PORTION OF THE LOT WITH NEW LIGHTING BEING WALL MOUNTED OFF THE BUILDING FOR SOUTH AND WEST ILLUMINATION OF

THE ENCLOSED YARD. THERE ARE EXISTING UTILITIES TO THE BUILDINGS ON THE PROPERTY. THESE UTILITY CONNECTIONS ARE PROPOSED TO BE REUSED/RECONNECTED TO THE NEW MOD FACILITY (PLEASE SEE CIVIL ENGINEERING WATER AND SEWER PLAN C4.0).

PROPOSED BUILDING DESIGN:

THE EXTERIOR DESIGN OF THE BUILDING WILL UTILIZE METAL SIDING TO MATCH THE EXISTING EXPRESS SERVICE BUILDING LOCATED ON THE ADJACENT PROPERTY TO THE SOUTH WITH THE EAST FACADE FACING SOUTH TACOMA WAY HAVING A GLAZED STOREFRONT ENTRY SYSTEM. THE BUILDING WILL HAVE PARAPETS ON THE EAST, SOUTH AND WEST SIDES. THE OVERHEAD DOORS ALONG THE SOUTH FACADE WILL INCORPORATE HIGH GLAZED PANELS FOR NATURAL LIGHTING TO THE BAYS. THE TWO FRONT BAYS ARE PROPOSED AS A PHOTO STUDIO FOR TAKING PHOTOS OF VEHICLES TO SUPPORT TACOMA SUBARU ONLINE SALES.

THE PROPOSED PROJECT TEAM IS COMPRISED OF THE SAME DESIGNERS AND CONSTRUCTORS WHO COMPLETED THE TACOMA SUBARU EXPRESS FACILITY IN 2017 AND THE TACOMA SUBARU OFFICE EXPANSION IN 2021.

DRAWING INDEX

GENERAL: AØ.I COVER SHEET CODE ANALYSIS -AD-3 PRIVER OPE ANALYSIS ARCHITECTURAL:
AII ARCHITECTURAL SITE PLAN FLOOR PLANS, RCP'S & ROOF PLAN BUILDING ELEVATIONS A5.1 BUILDING SECTIONS, WALL TYPES & ROOF ASSEMBLY POOR SCHEDULE, DOOR TYPES & WINDOW TYPES FINISH SCHEDULE, INT. ELEVATIONS & ENLARGED PLANS

^ structural notes SØ.3 TYPICAL DETAILS TYPICAL DETAILS 50.4 50.5 TESTING AND INSPECTION NOTES TESTING AND INSPECTION NOTES SIN FOUND ATION PLAN MEZZANINE FRAMING PLAN S1.2 ROOF FRAMING PLAN FOUNDATION DETAILS FLOOR FRAMING DEATILS ROOF FRAMING DETAILS

THESE DRAWINGS ARE UNDER SEPARATE CONTRACT RELATED TO SITE DEVELOPMENT PERMIT <u>CIVIL</u>: CØ.1 SDEV23-0202 COVER SHEET C1.0 TESC PLAN TESC NOTES AND DETAILS C1.1 C2.Ø SITE PLAN SITE NOTES AND DETAILS C2.1 C2.2 SITE NOTES AND DETAILS GRADING AND DRAINAGE PLAN C3.1 DRAINAGE NOTES AND DETAILS DRAINAGE NOTES AND DETAILS C3.2 C4.Ø WATER AND SEWER PLAN UTILITY NOTES AND DETAILS C4.1 \wedge PLUMBING:

COVER PAGE NOTES & SCHEDULES BELOW GRADE DRAIN, WASTE & VENT FLOOR PLAN SANITARY VENT FLOOR PLAN DOMESTIC WATER FLOOR PLAN

MECHANICAL LEGEND, ABBREVIATIONS, AND GENERAL NOTES

MECHANICAL FIRST FLOOR PLAN DETAILS DETAILS II SCHEDULES SEQUENCES SPECIFICATIONS

ELECTRICAL LEGEND/LIGHT FIXTURE SCHEDULE ELECTRICAL SITE PLAN El.Ø PARTIAL MAIN FLOOR LIGHTING PLAN E2.Ø PARTIAL MAIN FLOOR LIGHTING PLAN PARTIAL MAIN FLOOR POWER/SIGNAL PLAN E3.Ø PARTIAL MAIN FLOOR POWER/SIGNAL PLAN E3.1 MEZZANINE ELECTRICAL PLANS

E5.Ø POWER RISER DIAGRAM ELECTRICAL SCHEDULES

RELATED PERMITS

• PRE22-0206 • SDEV23-0202

DEFERRED PERMIT SUBMITTALS

• PRE-ENGINEERED CANOPY DESIGN PRE-ENGINEERED WOOD I-JOIST/OPEN WEB JOIST DESIGN

1130 Broadway Suite 207 Tacoma, WA 98402 253.383.7762 www.boearc.com

PROJECT:

TACOMA SUBARU BUILDING

3812 S TACOMA WAY TACOMA, WA

BRUCE TITUS AUTOMOTIVE GROUP

GENERAL NOTES:

REVISIONS:

C.O.T. COMMENT RESPONSE /<u>1</u>\ 10.03.2023

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DATE: 24 MAY 2023



PROJECT NO.: 2202.00 FILE NAME: DRAWN BY: CHECKED BY: DB PLOT SCALE: DRAWING SCALES: AS NOTED

DRAWING CONTENTS:

COVER SHEET

DRAWING NO.:



TACOMA SUBARU MOD BUILDING

FOR BRUCE TITUS AUTOMOTIVE GROUP

3812 S TACOMA WAY TACOMA, WA 98409 PARCEL NO. 0220131004

PROJECT TEAM

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LICENSE NO: HILGECIØ33QK

CONTACT: CALEB HILGER NICK HILGER CALEB.HILGER@HILGERCONSTRUCTION.COM NICK.HILGER@HILGERCONSTRUCTION.COM PHONE: (253) 584-4766

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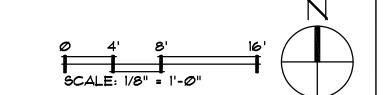
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PROJECT & CODE INFORMATION PROJECT: ACCESSIBLE EXITS: ALL EXITS AT FIRST FLOOR ARE ACCESSIBLE. TACOMA SUBARU MOD BUILDING IBC SECTION 1009 MEZZANINE AREA = 379 SF < 3,000 SF ADDRESS: 3812 S TACOMA WAY, TACOMA, WA 98409 IBC SECTION 1104.4 THEREFORE, MEZZANINE DOES NOT REQUIRE ACCESSIBLE ROUTE EXCEPTION I PER IBC SECTION 1104.4 EXCEPTION 1 TAX PARCEL NUMBER: 0220131004 EACH DOOR SHALL HAVE A CLEAR WIDTH OF 32". SIZE OF DOORS CODE: INTERNATIONAL BUILDING CODE (IBC) INTERNATIONAL FIRE CODE (IFC), IBC SECTION 1010.1.1 ALL PROPOSED DOORS TO BE AT LEAST 32" WIDE, AS ADOPTED BY WASHINGTON STATE AND CITY OF TACOMA THEREFORE OK. EGRESS DOORS SHALL SWING IN DIRECTION OF EGRESS TRAVEL IF SERVING AN IBC OCC. ZONING DISTRICT: M-1 (LIGHT INDUSTRIAL) DOOR SWING DIRECTION IBC SECTION 1010.1.2 LOAD OF 50 OR MORE WITH SINGLE TENANT OCCUPANCY. B OCCUPANCY: TOTAL OCC. LOAD < 49. APPROXIMATELY 23'-0" ABOVE GRADE EXCEPTION I BUILDING HEIGHT: THEREFORE DOOR NOT REQUIRED TO SWING IN DIRECTION OF TRAVEL 5-1 OCCUPANCY: TOTAL OCC. LOAD PER EXIT COMPARTMENT IS 10 OR LESS, BUILDING STORIES: 1 STORY (WITH MEZZANINE) THEREFORE OVERHEAD GARAGE DOOR OK FOR EGRESS USE PER EXCEPTION I BUILDING AREA: FIRST FLOOR: 5,562 SF DOOR OPENING FORCE: FORCE REQ'D FOR INTERIOR EGRESS DOORS, OTHER THAN FIRE DOORS < 5-POUNDS. ALL MEZZANINE: 379 SF OTHER DOORS: DOOR LATCH SHALL RELEASE WITH 15-POUND FORCE. THE DOOR SHALL TOTAL BUILDING: 5,941 SF IBC SECTION 1010.1.3 BE SET IN MOTION WITH 30-POUND FORCE. THE DOOR SHALL SWING TO A FULL-OPEN B (BUSINESS), S-I (MOTOR VEHICLE REPAIR GARAGE) OCCUPANCY GROUPS POSITION WITH 15-POUND FORCE. STAIRWAYS SERVING AN OCCUPANT LOAD OF LESS THAN 50 SHALL HAVE A WIDTH OF STAIRWAYS: CONSTRUCTION TYPE: TYPE V-B IBC SECTION 1011.2 NOT LESS THAN 36 INCHES. FIRE SPRINKLER: NO EXCEPTION I OCCUPANT LOAD < 50, STAIRWAY WIDTH = 36", THEREFORE OK. PARKING CALCULATIONS: PER JENNIFER KAMMERZELL, INTERIM DIVISION MANAGER EXIT ACCESS: EXIT ACCESS THROUGH ADJOINING ROOMS IS ALLOWED PER IBC SECTION 1016.2-2 AS TMC 13.06.090.C-3(c)\$(h) CITY OF TACOMA - PUBLIC WORKS DEPARTMENT INTERVENING ROOMS AND AREAS ARE ACCESSORY TO ONE ANOTHER. IBC SECTION 1016 EMAIL OF 09/19/2022: EXIT ACCESS TRAVEL DIST .: B OCCUPANCY, WITHOUT FIRE SPRINKLER SYSTEM: 200' MAXIMUM ALLOWED. I PARKING STALL PER BAY = 9 BAYS = 9 PARKING STALLS PROPOSED MAXIMUM TRAVEL DISTANCE APPROX. 65'-0" (SEE CODE FLOOR PLAN). OFFICE: 185 SF / 1,000 SF x 3 = 2.355 PARKING STALLS IBC TABLE 1017.2 THEREFORE, O.K. STORAGE: 928 SF / 2,000 SF x 1 = 0.464 PARKING STALL 5-1 OCCUPANCY, WITHOUT FIRE SPRINKLER SYSTEM: 200' MAXIMUM ALLOWED. TOTAL: 9 + 2,355 + 0.464 = 11.819 = 12 PARKING STALLS 12 PARKING STALLS < 13 PARKING STALLS PROPOSED, THEREFORE O.K. PROPOSED MAXIMUM TRAVEL DISTANCE APPROX. 31'-0" (SEE CODE FLOOR PLAN), THEREFORE, O.K. RISK CATEGORY: CATEGORY I IBC TABLE 1604.5 DEAD END CORRIDORS: NO DEAD END CORRIDORS PROPOSED. IBC SECTION 1020.4 ALLOWABLE HEIGHT TYPE V-B CONSTRUCTION, B, S-1 OCCUPANCIES, NON-SPRINKLED EXCEPTION 2 IBC TABLE 504.3 40'-0" MAXIMUM HEIGHT ALLOWED > 23'-0" +/- PROPOSED, THEREFORE O.K. FOR AREAS SERVING LESS THAN 50 OCCUPANTS, THE COMMON PATH OF EGRESS TRAVEL COMMON PATH OF TRAVEL: TYPE V-B CONSTRUCTION, B. S-1 OCCUPANCIES, NON-SPRINKLED IBC SECTION 1030.8 ALLOWABLE STORIES: SHALL NOT EXCEED 15 FEET. 1 STORY ALLOWED = 1 STORY (WITH MEZZANINE) PROPOSED, THEREFORE O.K. IBC TABLE 504.4 EXCEPTION I ALL AREAS ARE SERVING LESS THAN 50 OCCUPANTS. NO EXIT DISTANCE EXCEEDS 15 FEET PER EXCEPTION 1, IBC SECTION 10/10.12 ENCLOSED MEZZANINE: MEZZANINES OR PORTIONS THEREOF ARE NOT REQUIRED TO BE OPEN TO THEREFORE, O.K. IBC SECTION 505.2.3 THE ROOM IN WHICH THE MEZZANINES ARE LOCATED, PROVIDED THAT THE OCCUPANT LOAD OF THE AGGREGATE AREA OF THE ENCLOSED SPACE IS PLUMBING FIXTURES: EXCEPTION I B OCCUPANCY: NOT GREATER THAN 10. IBC TABLE 2902.1 WATERCLOSETS (WC) = 1 PER 25 IBC SECTION 2902.2 LAYATORIES (LAY) = 1 PER 40 ALLOWABLE AREA: B & S-1 OCCUPANCIES, TYPE V-B CONSTRUCTION, NON-SPRINKLED = 9,000 SF EXCEPTION 5 12/25 OCC. = 0.48 WC IBC SECTION 506 IBC SECTION 2902.2.1 12/40 OCC. = 0.30 LAV 9,000 SF ALLOWABLE > 5,941 SF PROPOSED, THEREFORE O.K. IBC TABLE 506.2 IBC SECTION 2902.2.2 5-1 OCCUPANCY: OCCUPANCY SEPARATION: OCCUPANCY USES: B, S-1 WATERCLOSETS (WC) = 1 PER 100 NO SEPARATION REQUIRED PER IBC TABLE 508.4 LAYATORIES (LAY) = 1 PER 100 IBC TABLE 508.4 21/100 OCC. = 0.21 WC FIRE-RESISTIVE REQUIREMENTS: CONSTRUCTION TYPE V-B 21/100 OCC. = 0.21 LAV PRIMARY STRUCTURAL FRAME: Ø-HR, IBC TABLE 601 NON-COMBUSTIBLE BEARING WALLS-EXTERIOR: Ø-HR, NON-COMBUSTIBLE BEARING WALLS-INTERIOR: Ø-HR, 0.48 WC + 0.21 WC = 0.69 WC = 1 WC x 2 GENDER SPLIT = 2 WC REQ. 0.30 LAV + 0.21 LAV = 0.51 LAV = 1 LAV x 2 GENDER SPLIT = 2 LAV REQ. NON-COMBUSTIBLE NON-BEARING WALLS-INTERIOR: Ø-HR, NON-COMBUSTIBLE FLOOR CONSTRUCTION: Ø-HR, 2 WC REQ. = 2 WC PROPOSED, THEREFORE O.K. NON-COMBUSTIBLE ROOF CONSTRUCTION: Ø-HR. 2 LAV REQ. = 2 LAV PROPOSED, THEREFORE O.K. 2 GENDER-NEUTRAL FACILITIES PROPOSED. OCCUPANT LOAD: FIRST FLOOR = 30 OCCUPANTS IBC TABLE 1004.5 MEZZANINE = 3 OCCUPANTS SEPARATE FACILITIES SHALL NOT BE REQUIRED WHEN GENDER-NEUTRAL FACILITIES ARE PROVIDED IN ACCORDANCE WITH SECTION 2902.2.2 TOTAL = 33 OCCUPANTS EGRESS SIZING: CAPACITY FACTOR OF 0.2" PER OCCUPANT. PORTABLE FIRE EXTINGUISHERS: MAXIMUM DISTANCE OF TRAVEL = 75' FIRST FLOOR: 30 OCC. x 0.2" = 6" < 72" PROVIDED IBC SECTION 1005.3.2 IFC SECTION 906 MINIMUM RATED SINGLE EXTINGUISHER = 2-A MEZZANINE: 3 OCC. x 0.2" = 0.6" = 1" < 36" PROVIDED THEREFORE O.K. OCCUPANT LOAD BETWEEN 1-500: MIN NUMBER OF EXITS: IBC TABLE 1006.3.2 B OCCUPANCY: I EXIT REQ. I EXIT PROPOSED, THEREFORE, O.K. IBC TABLE 1006.3.3(2) S-1 OCCUPANCY: 1 EXITS REQ. I EXIT PROPOSED, THEREFORE, O.K.



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3812 S TACOMA WAY TACOMA, WA

BRUCE TITUS AUTOMOTIVE GROUP

GENERAL NOTES:

REVISIONS:

C.O.T. COMMENT RESPONSE 10.03.2023

AGENCY REVIEW DATE: 24 MAY 2023 REGISTERE ARCHITECT

DRAWING ISSUED FOR:

PROJECT NO.: 22*Ø*2*.*ØØ FILE NAME:

DB


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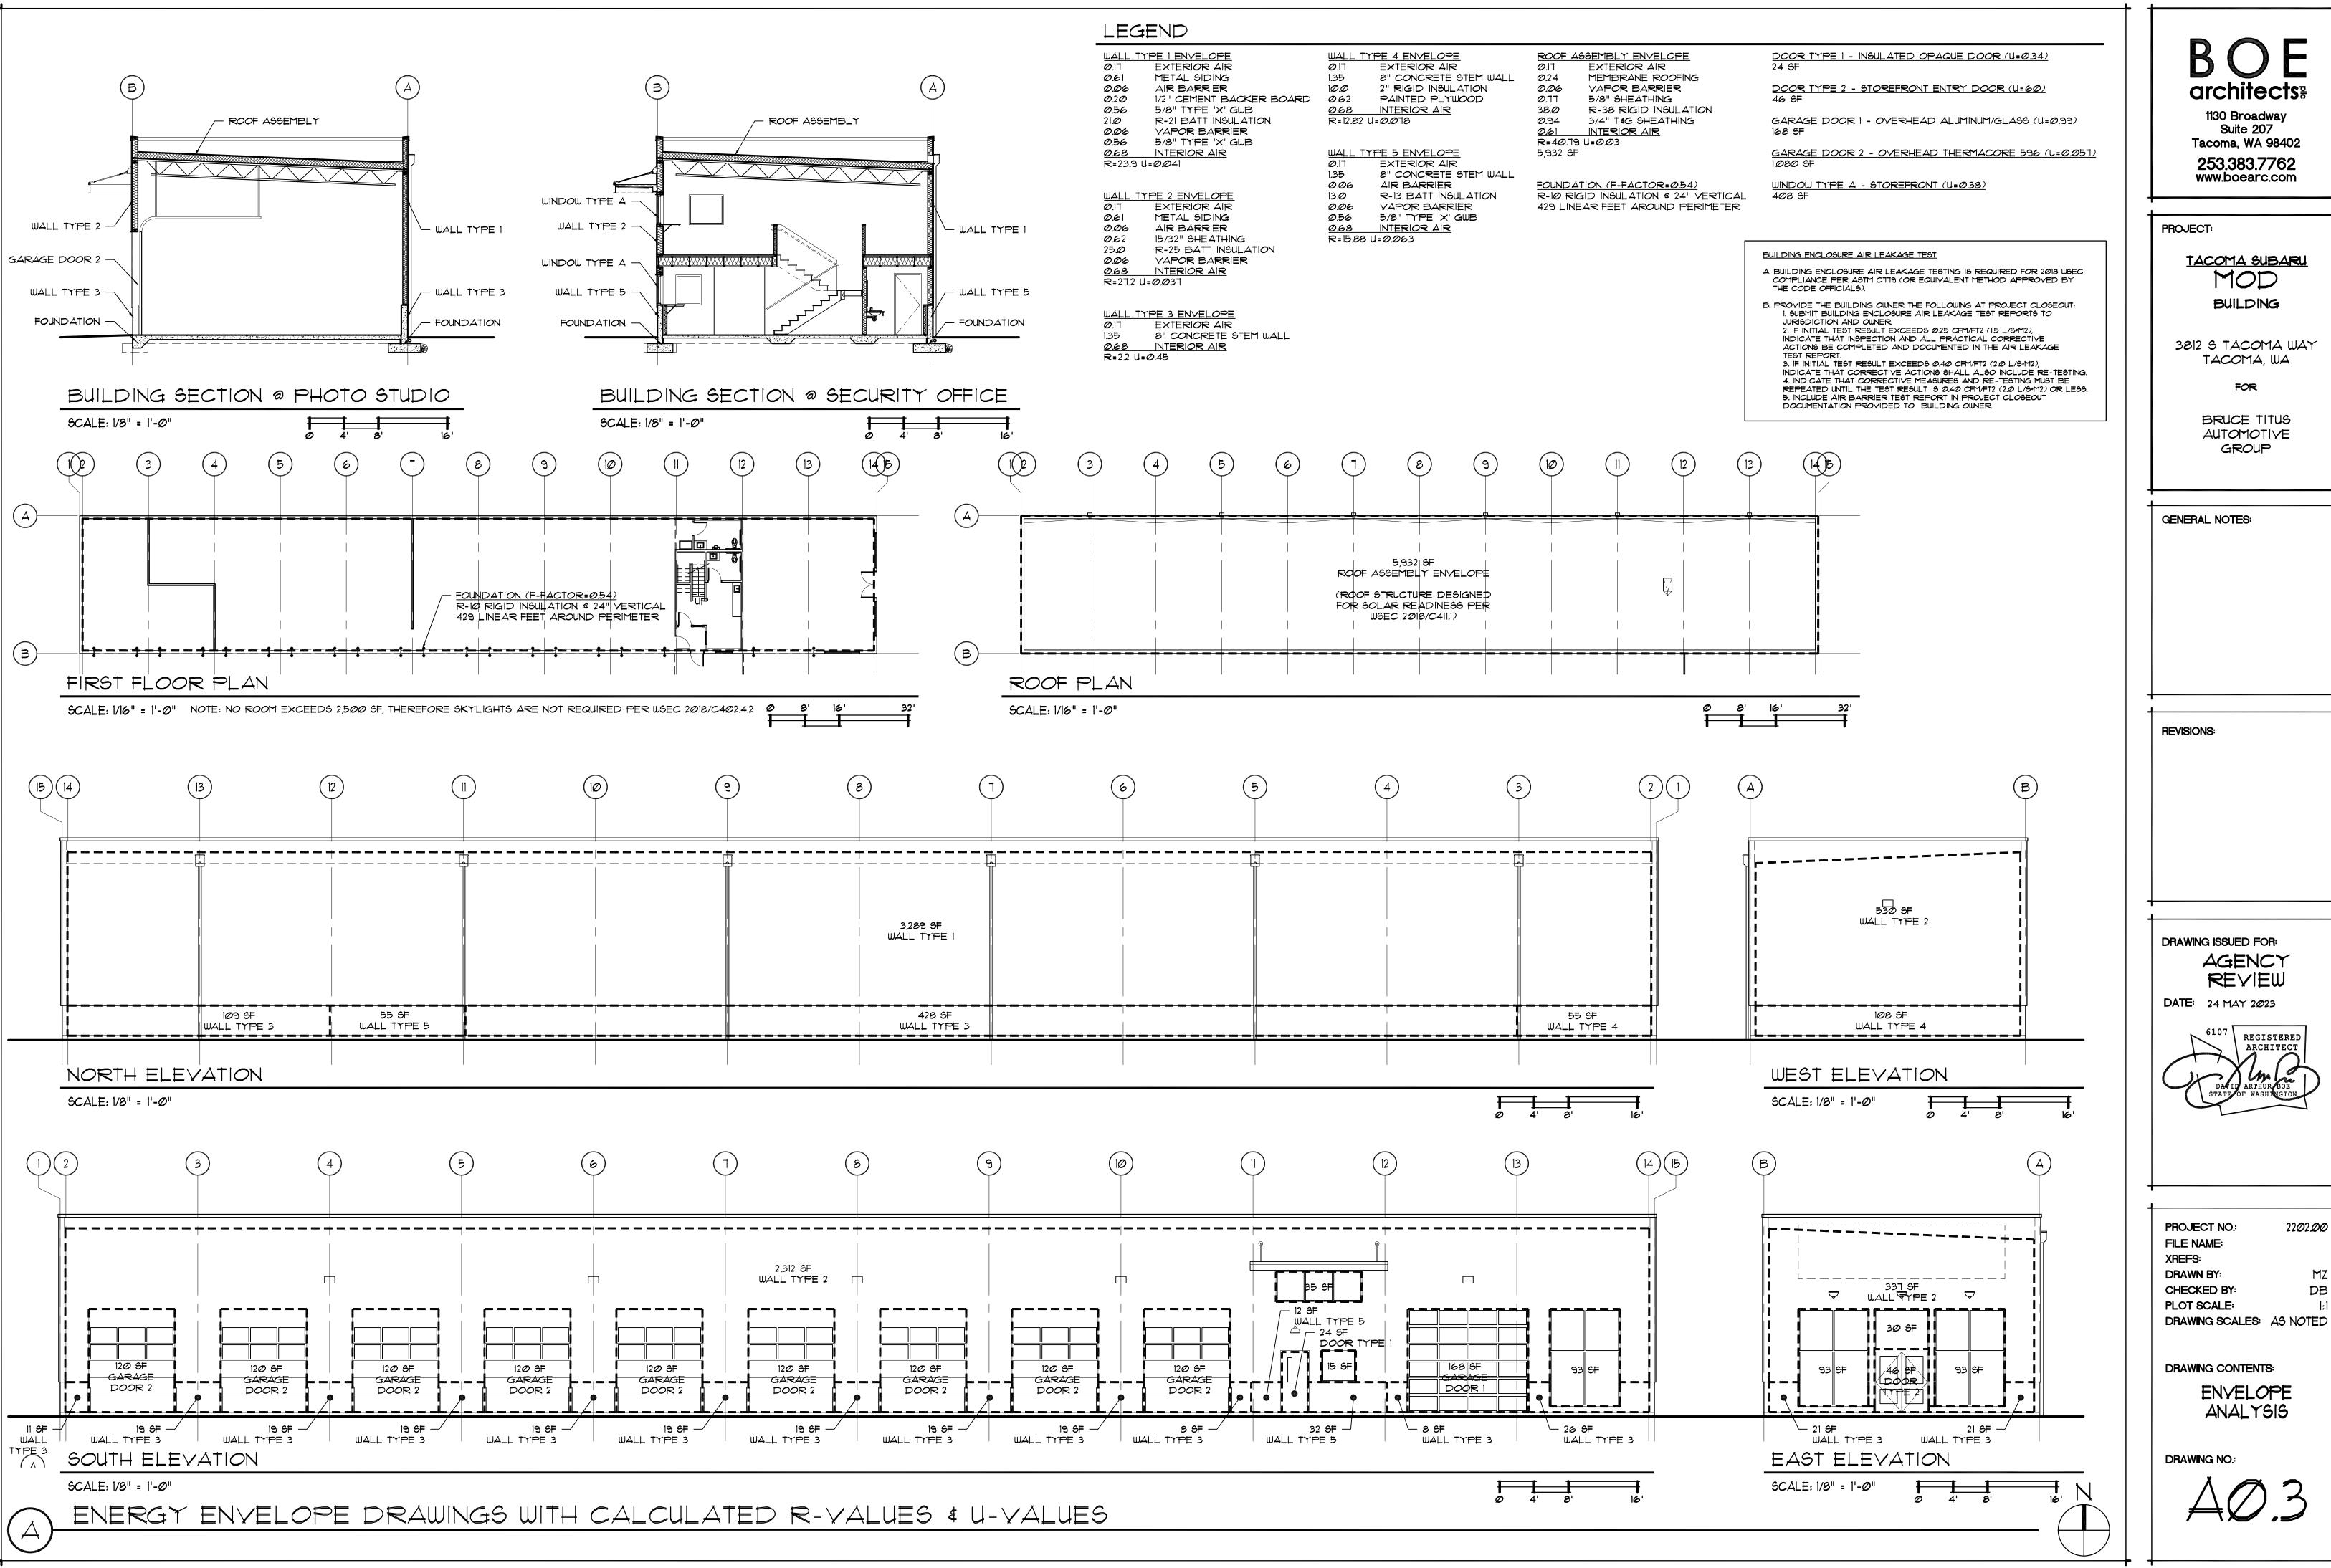
PLOT SCALE: DRAWING SCALES: AS NOTED

DRAWING CONTENTS:

CODE ANALYSIS

DRAWING NO.:



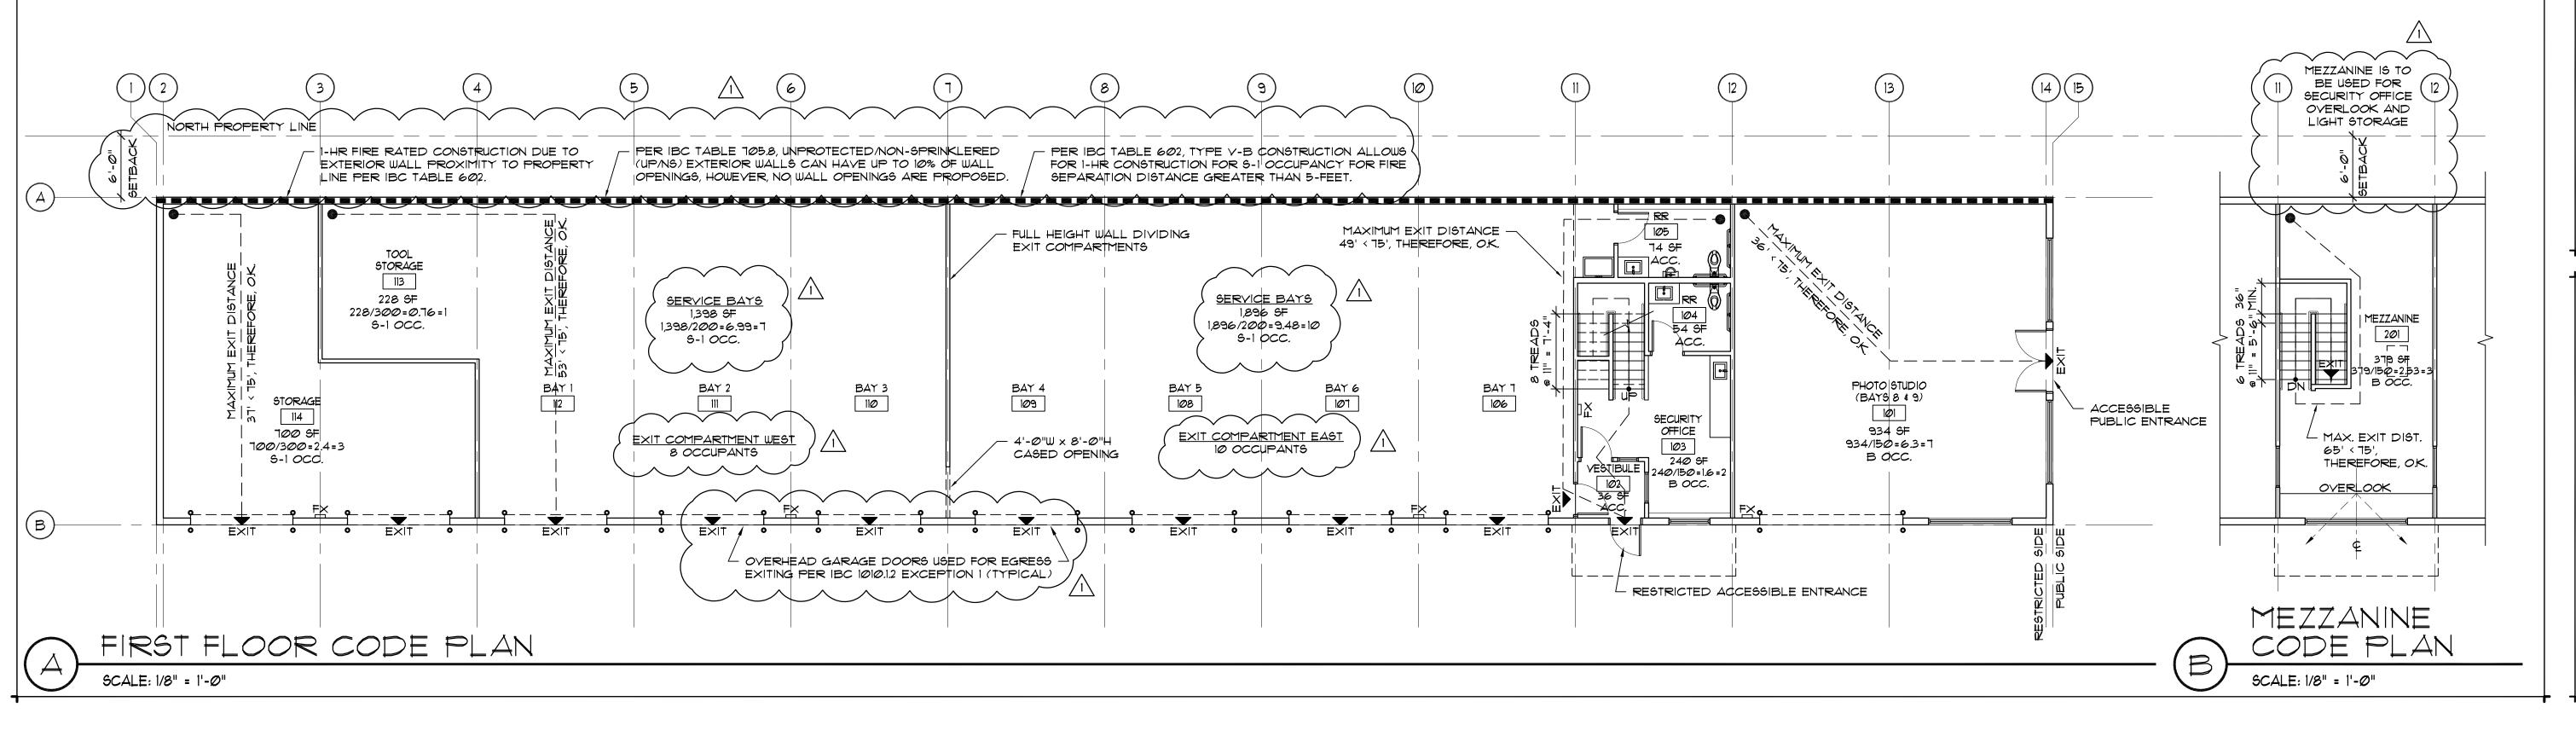

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TACOMA SUBARU

3812 S TACOMA WAY TACOMA, WA

> BRUCE TITUS AUTOMOTIVE GROUP

AGENCY REVIEW

REGISTERED ARCHITECT

22*0*2*.00*

ENVELOPE

- ALIGN FRONT ELEVATION WITH PER IBC TABLE 705.8, EXPRESS SERVICE FACILITY FACADE PER IBC TABLE 602, TYPE UNPROTECTED/NON-SPRINKLERED 183'-7" NOM. V-B CONSTRUCTION ALLOWS (UP/NS) EXTERIOR WALLS CAN FOR 1-HR CONSTRUCTION FOR 5-1 OCCUPANCY FOR FIRE SEPARATION DISTANCE HAVE UP TO 10% OF WALL SETBACK 711/-6" NOM. - LANDING IS FLAT ALONG OPENINGS, HOWEVER, NO WALL BUILDING WITH MAX. 2% SLOPE EAST THROUGH END SETBACK OPENINGS ARE PROPOSED. GREATER THAN 5-FEET. OF ACCESSIBLE AISLE MAX. 5% \$LOPE WITH MAX. 2% CROSS SLOPE TO SOUTH N88°15'43"W 440.74' ACCESSIBLE PARKING STĄLL - REMAINDER OF SIDEWALK IS FLAT WITH MAX. 2% CROSS. RIM=262.45— SLOPE TO SOUTH FOR DRAINAGE PROPOSED # ACCESS ANSLE BUILDING - SLOPE UP AT MAX. 5% WITH CROSS SLOPE MT-262.66-MAX. 2% - 8 FT WIDE ENTRY WALK LARGE OVERHANGING BILLBOARD— SIGN WITH METAL POLE FLAT ALONG BUILDING SLOPE TO EAST AT 2% -R=2764.79' L=101.71' Δ=2*06'28" TPN 0220131004 ___C.O. RIM=263.78 (3) MEDIUM TREES WITH A — CALCULATED CANOPY FACTOR FROM 40 TO 90 PER THE CITY OF TACOMA URBAN FORESTRY MANUAL EXISTING ROCK WALL NO CHANGE PROPOSED N88°15'43"W 447.50' TPN 0220131004 NO WORK ON TPU PROPERTY -N88°15'43"W 346.94' 2' WIDE CONCRETE-R=2668.86' ECO BLOCK WALL L=90.28' - EXISTING ADJACENT TACOMA SUBARU ∆=1°56'18" EXPRESS SERVICE FACILITY TPN 0220131004 ARCHITECTURAL SITE PLAN (SEE CIVIL ENGINEERING DOCUMENTS FOR DETAILED SCOPE OF WORK) SCALE: 1" = 20'-0"

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PROJECT:

TACOMA SUBARU
MOD
BUILDING

3812 S TACOMA WAY TACOMA, WA

FOF

BRUCE TITUS AUTOMOTIVE GROUP

GENERAL NOTES:

REVISIONS:


C.O.T. COMMENT RESPONSE

DRAWING ISSUED FOR:

AGENCY

REVIEW

DATE: 24 MAY 2023

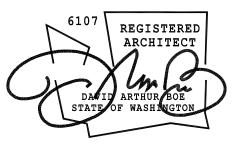

PROJECT NO.: 2202.00
FILE NAME:

XREFS:
DRAWN BY: MZ
CHECKED BY: DB
PLOT SCALE: 1:1
DRAWING SCALES: AS NOTED


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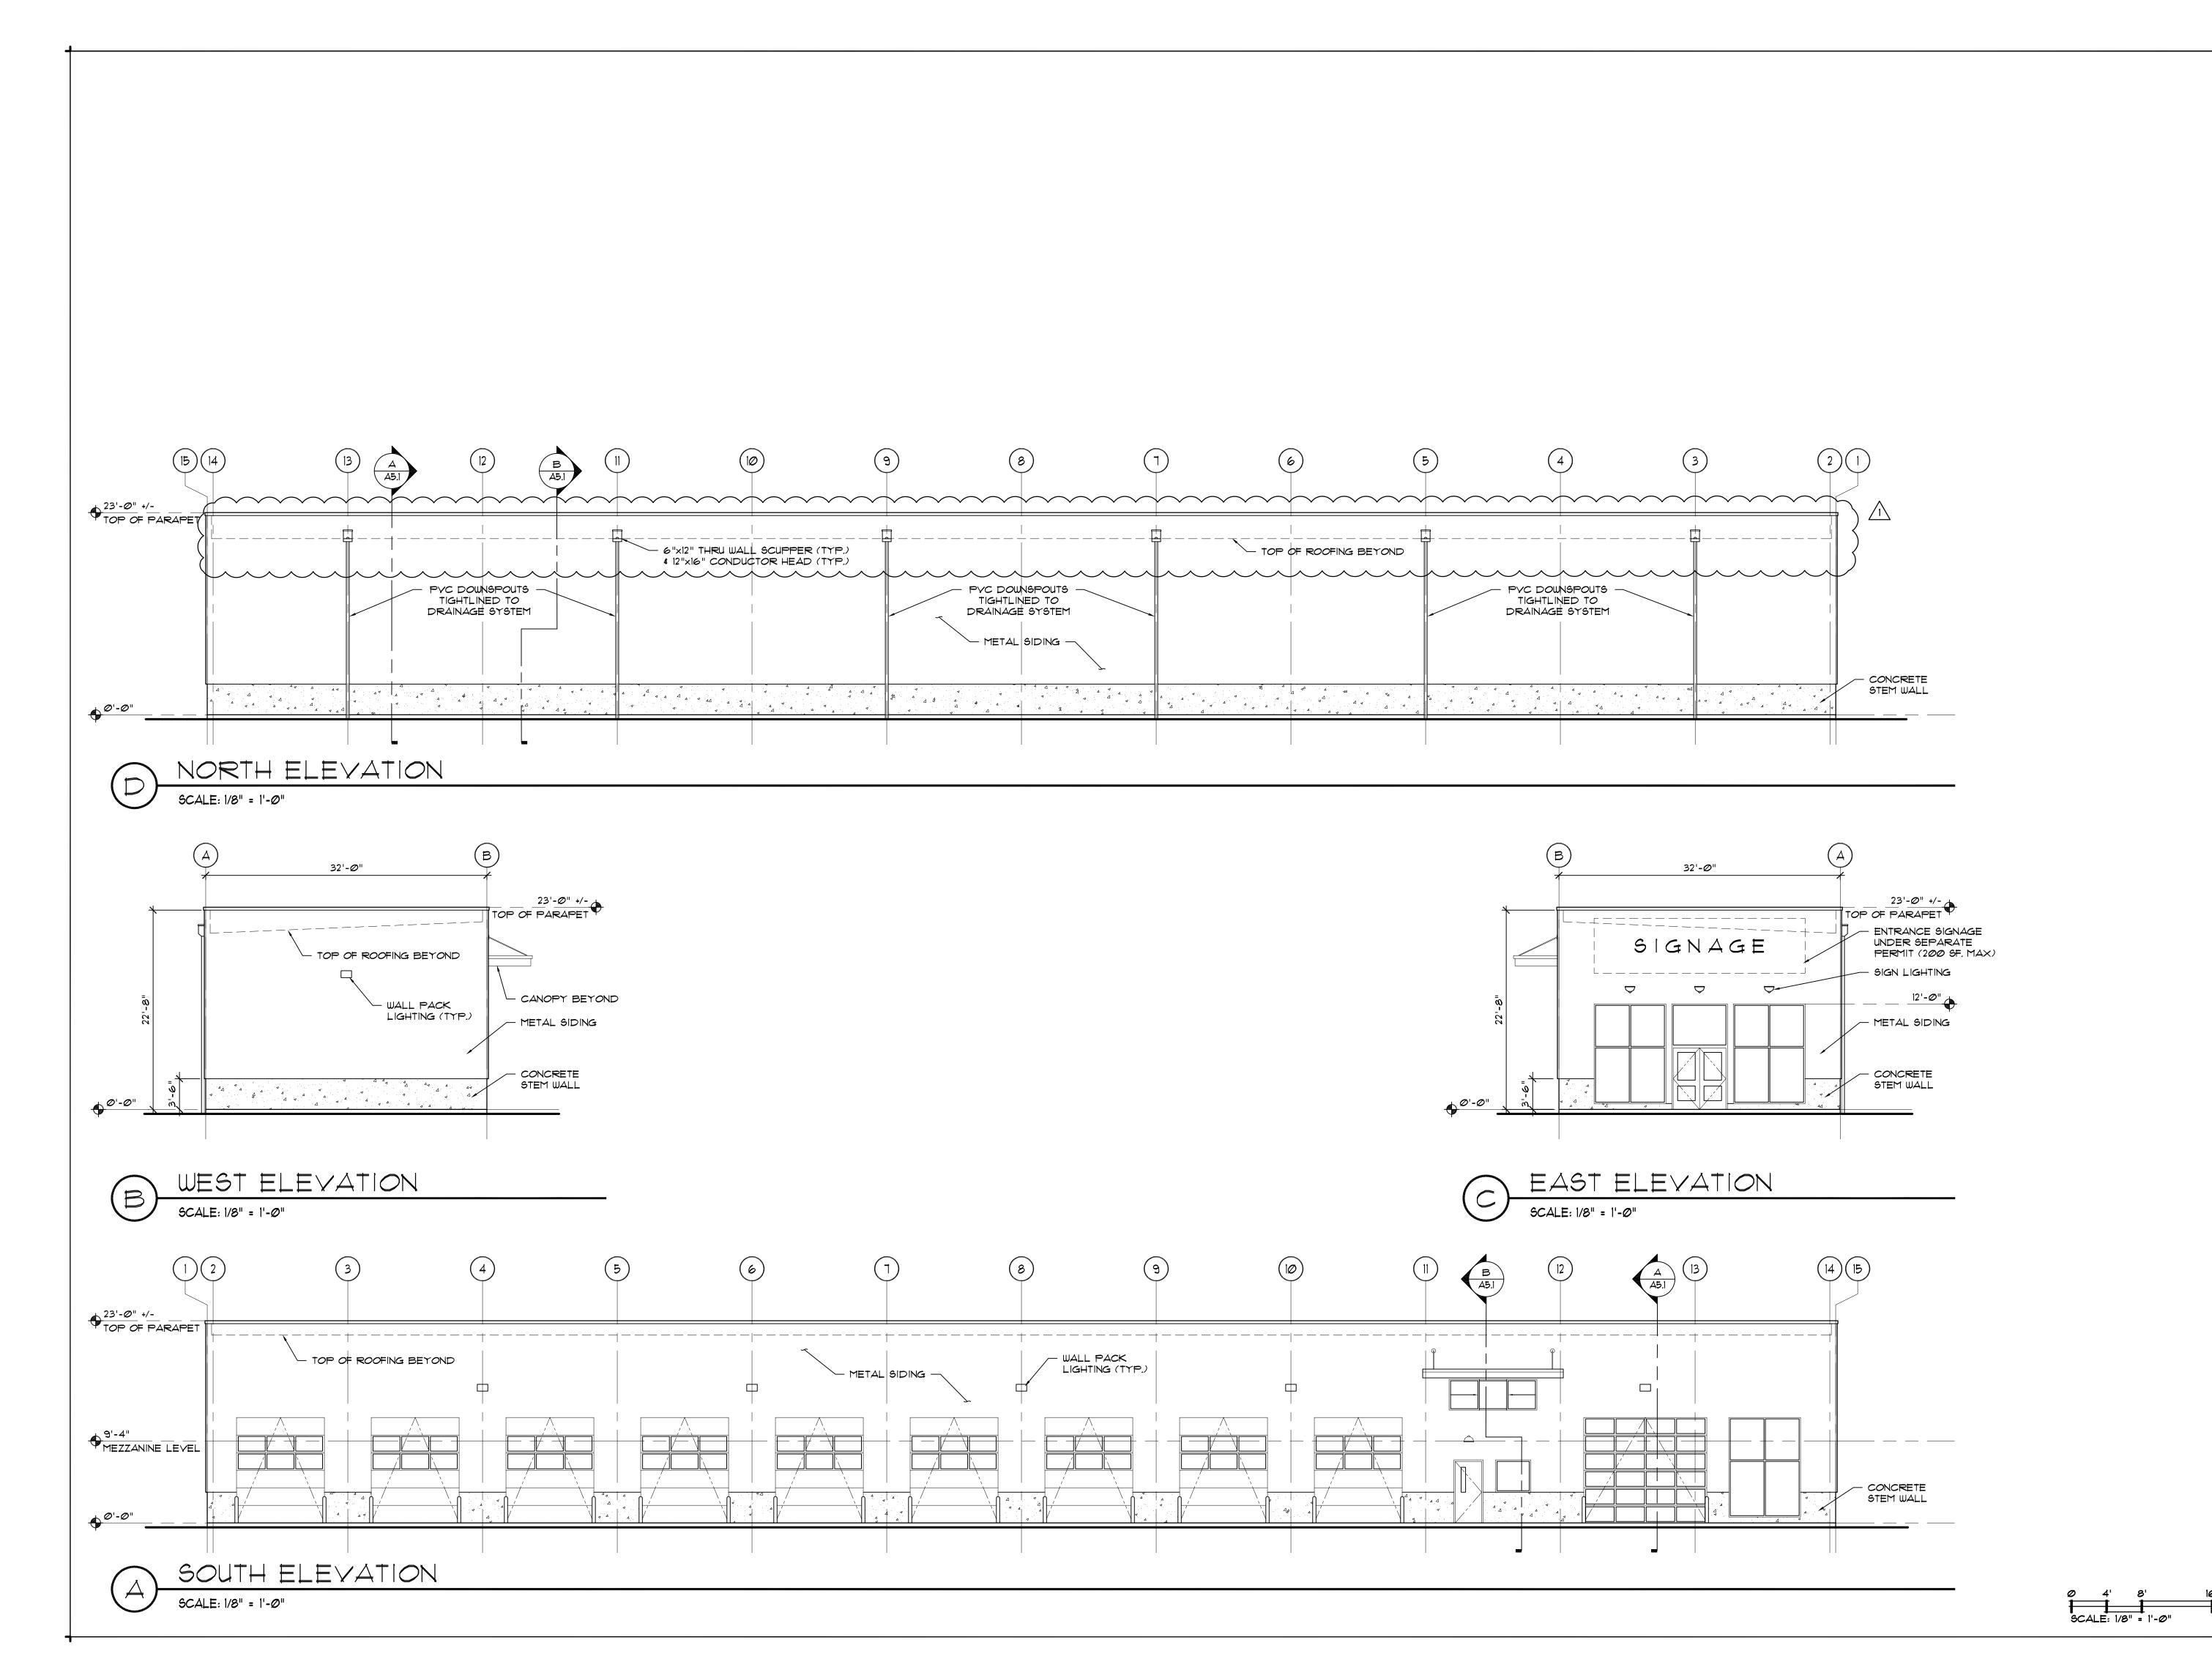
ARCHITECTURAL

SITE PLAN

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A1.1



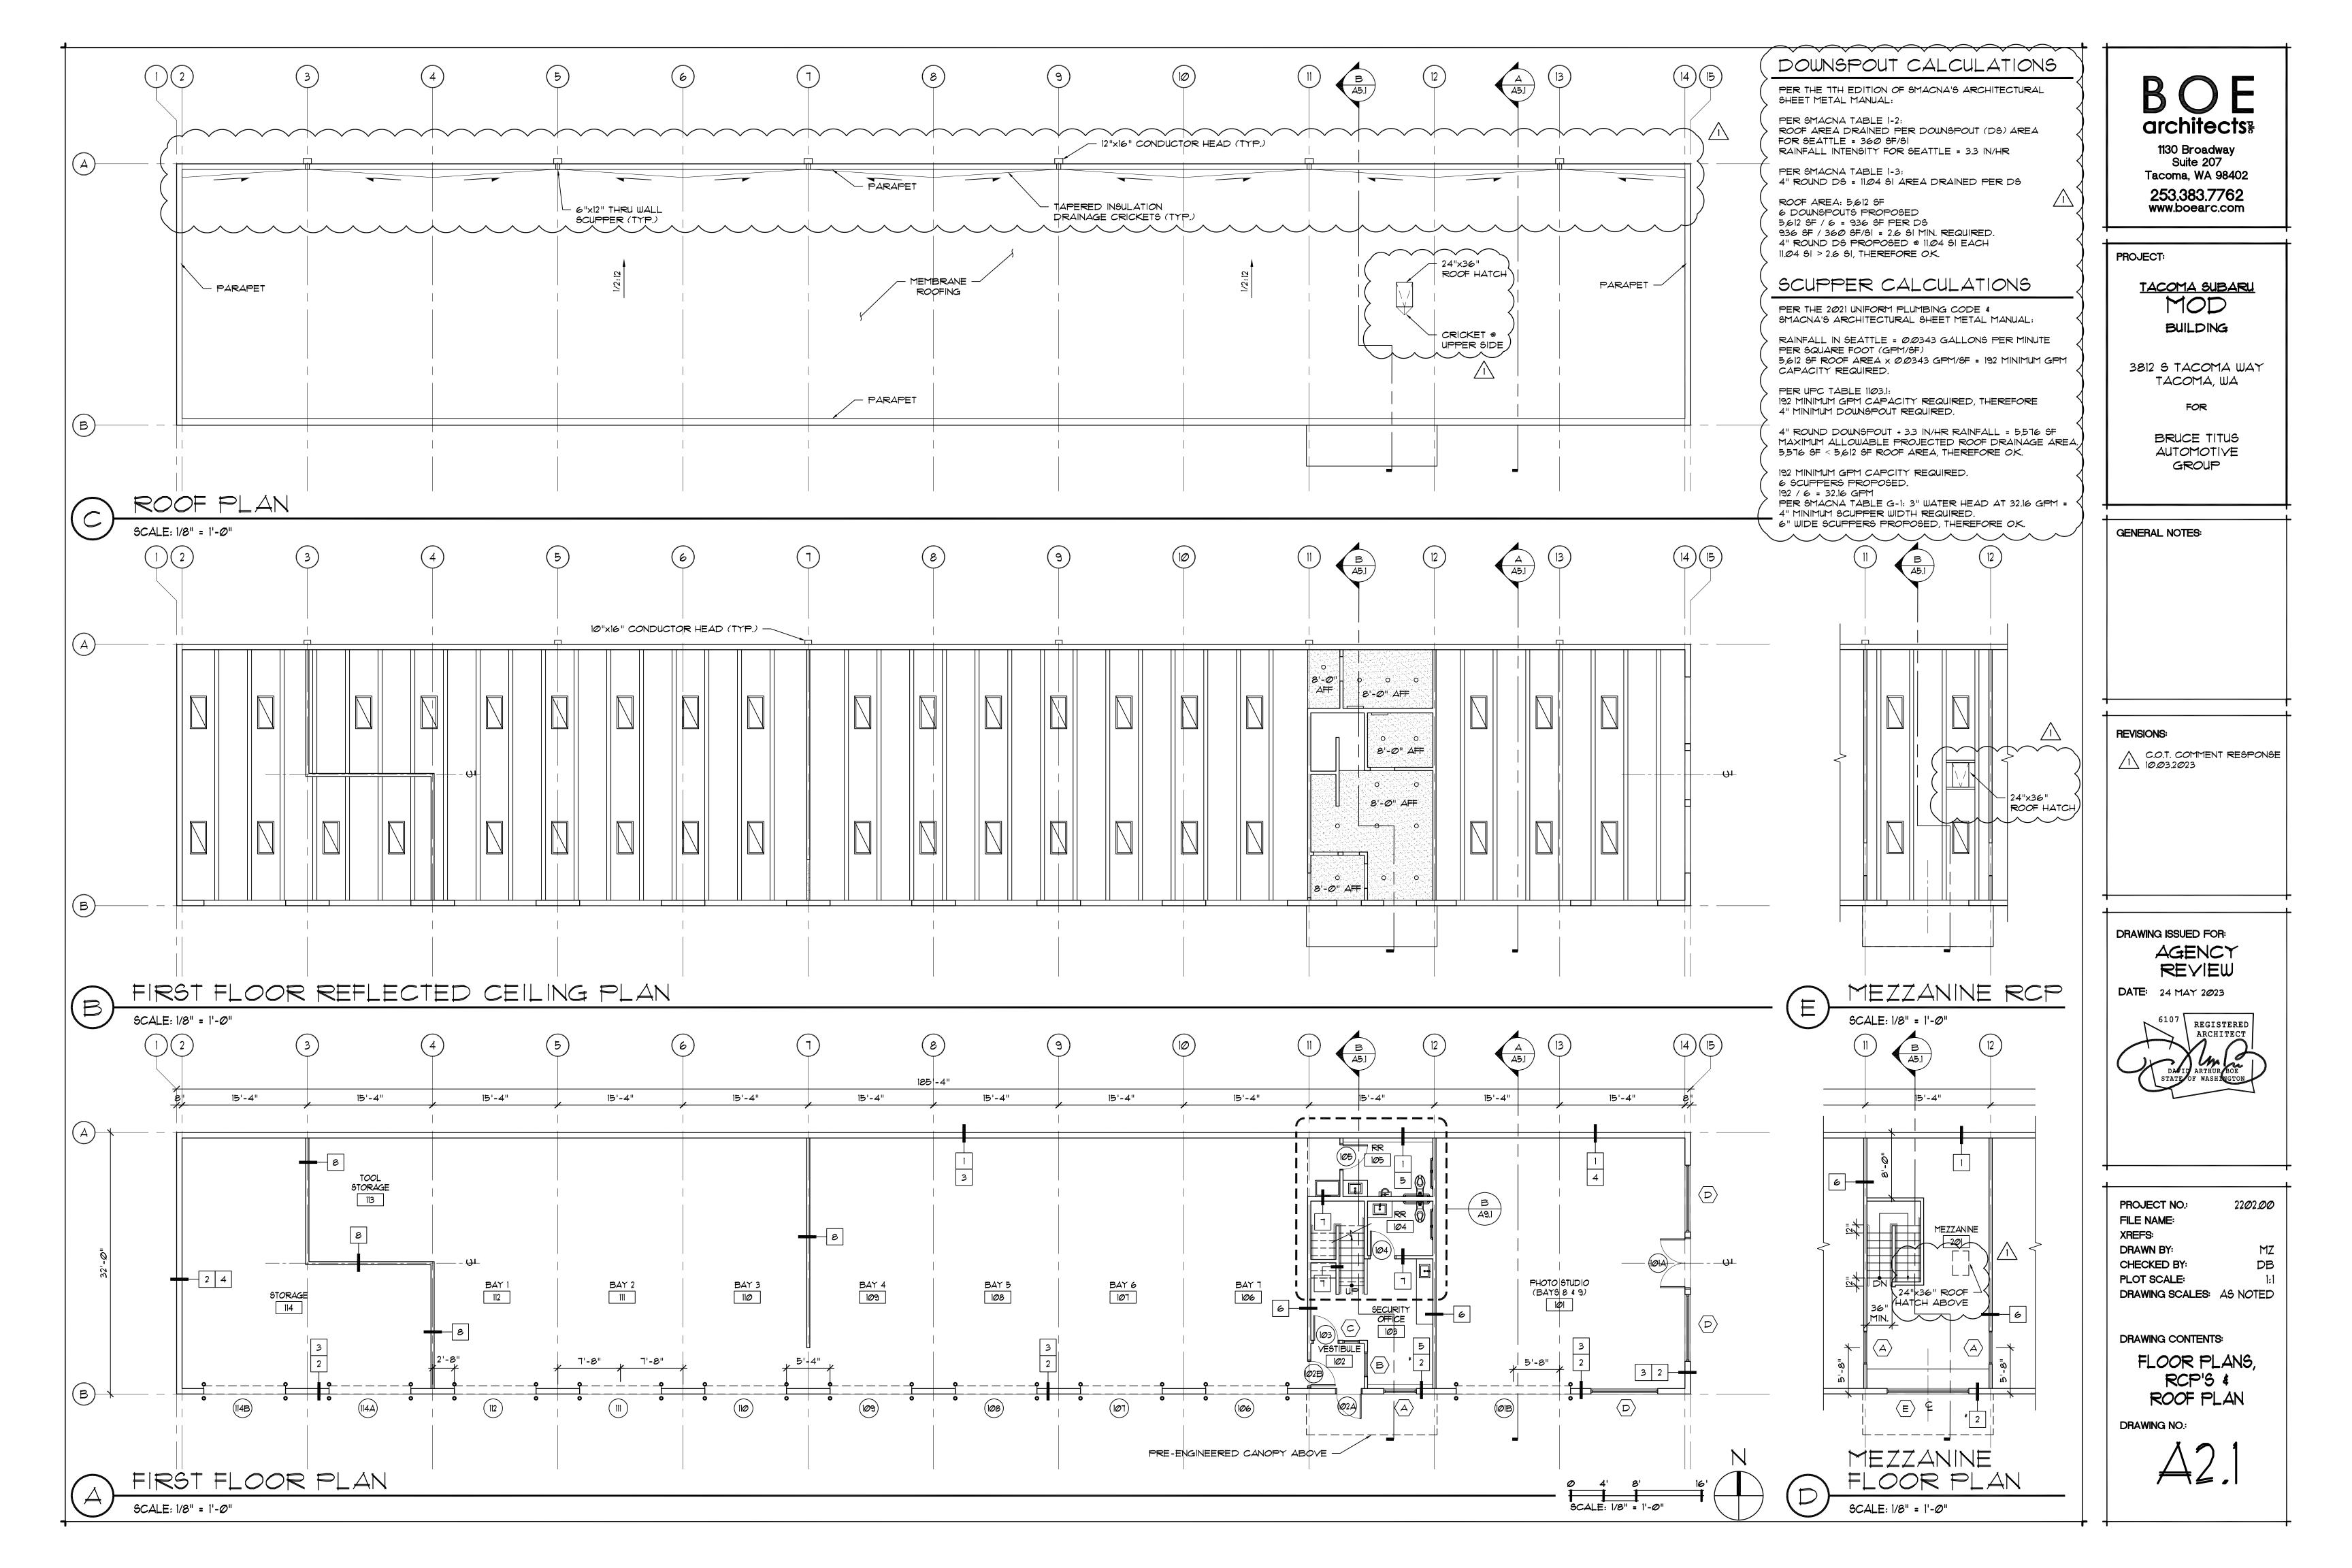

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DRAWING SCALES:


PLOT SCALE: 1:1

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BUILDING
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PROJECT NO: 2202.00
FILE NAME:
YDEES:

XREFS:
DRAWN BY: MZ
CHECKED BY: DB
PLOT SCALE: 1:1
DRAWING SCALES: AS NOTED

DRAWING CONTENTS:

BUILDING SECTIONS, WALL TYPES + ROOF ASSEMBLY

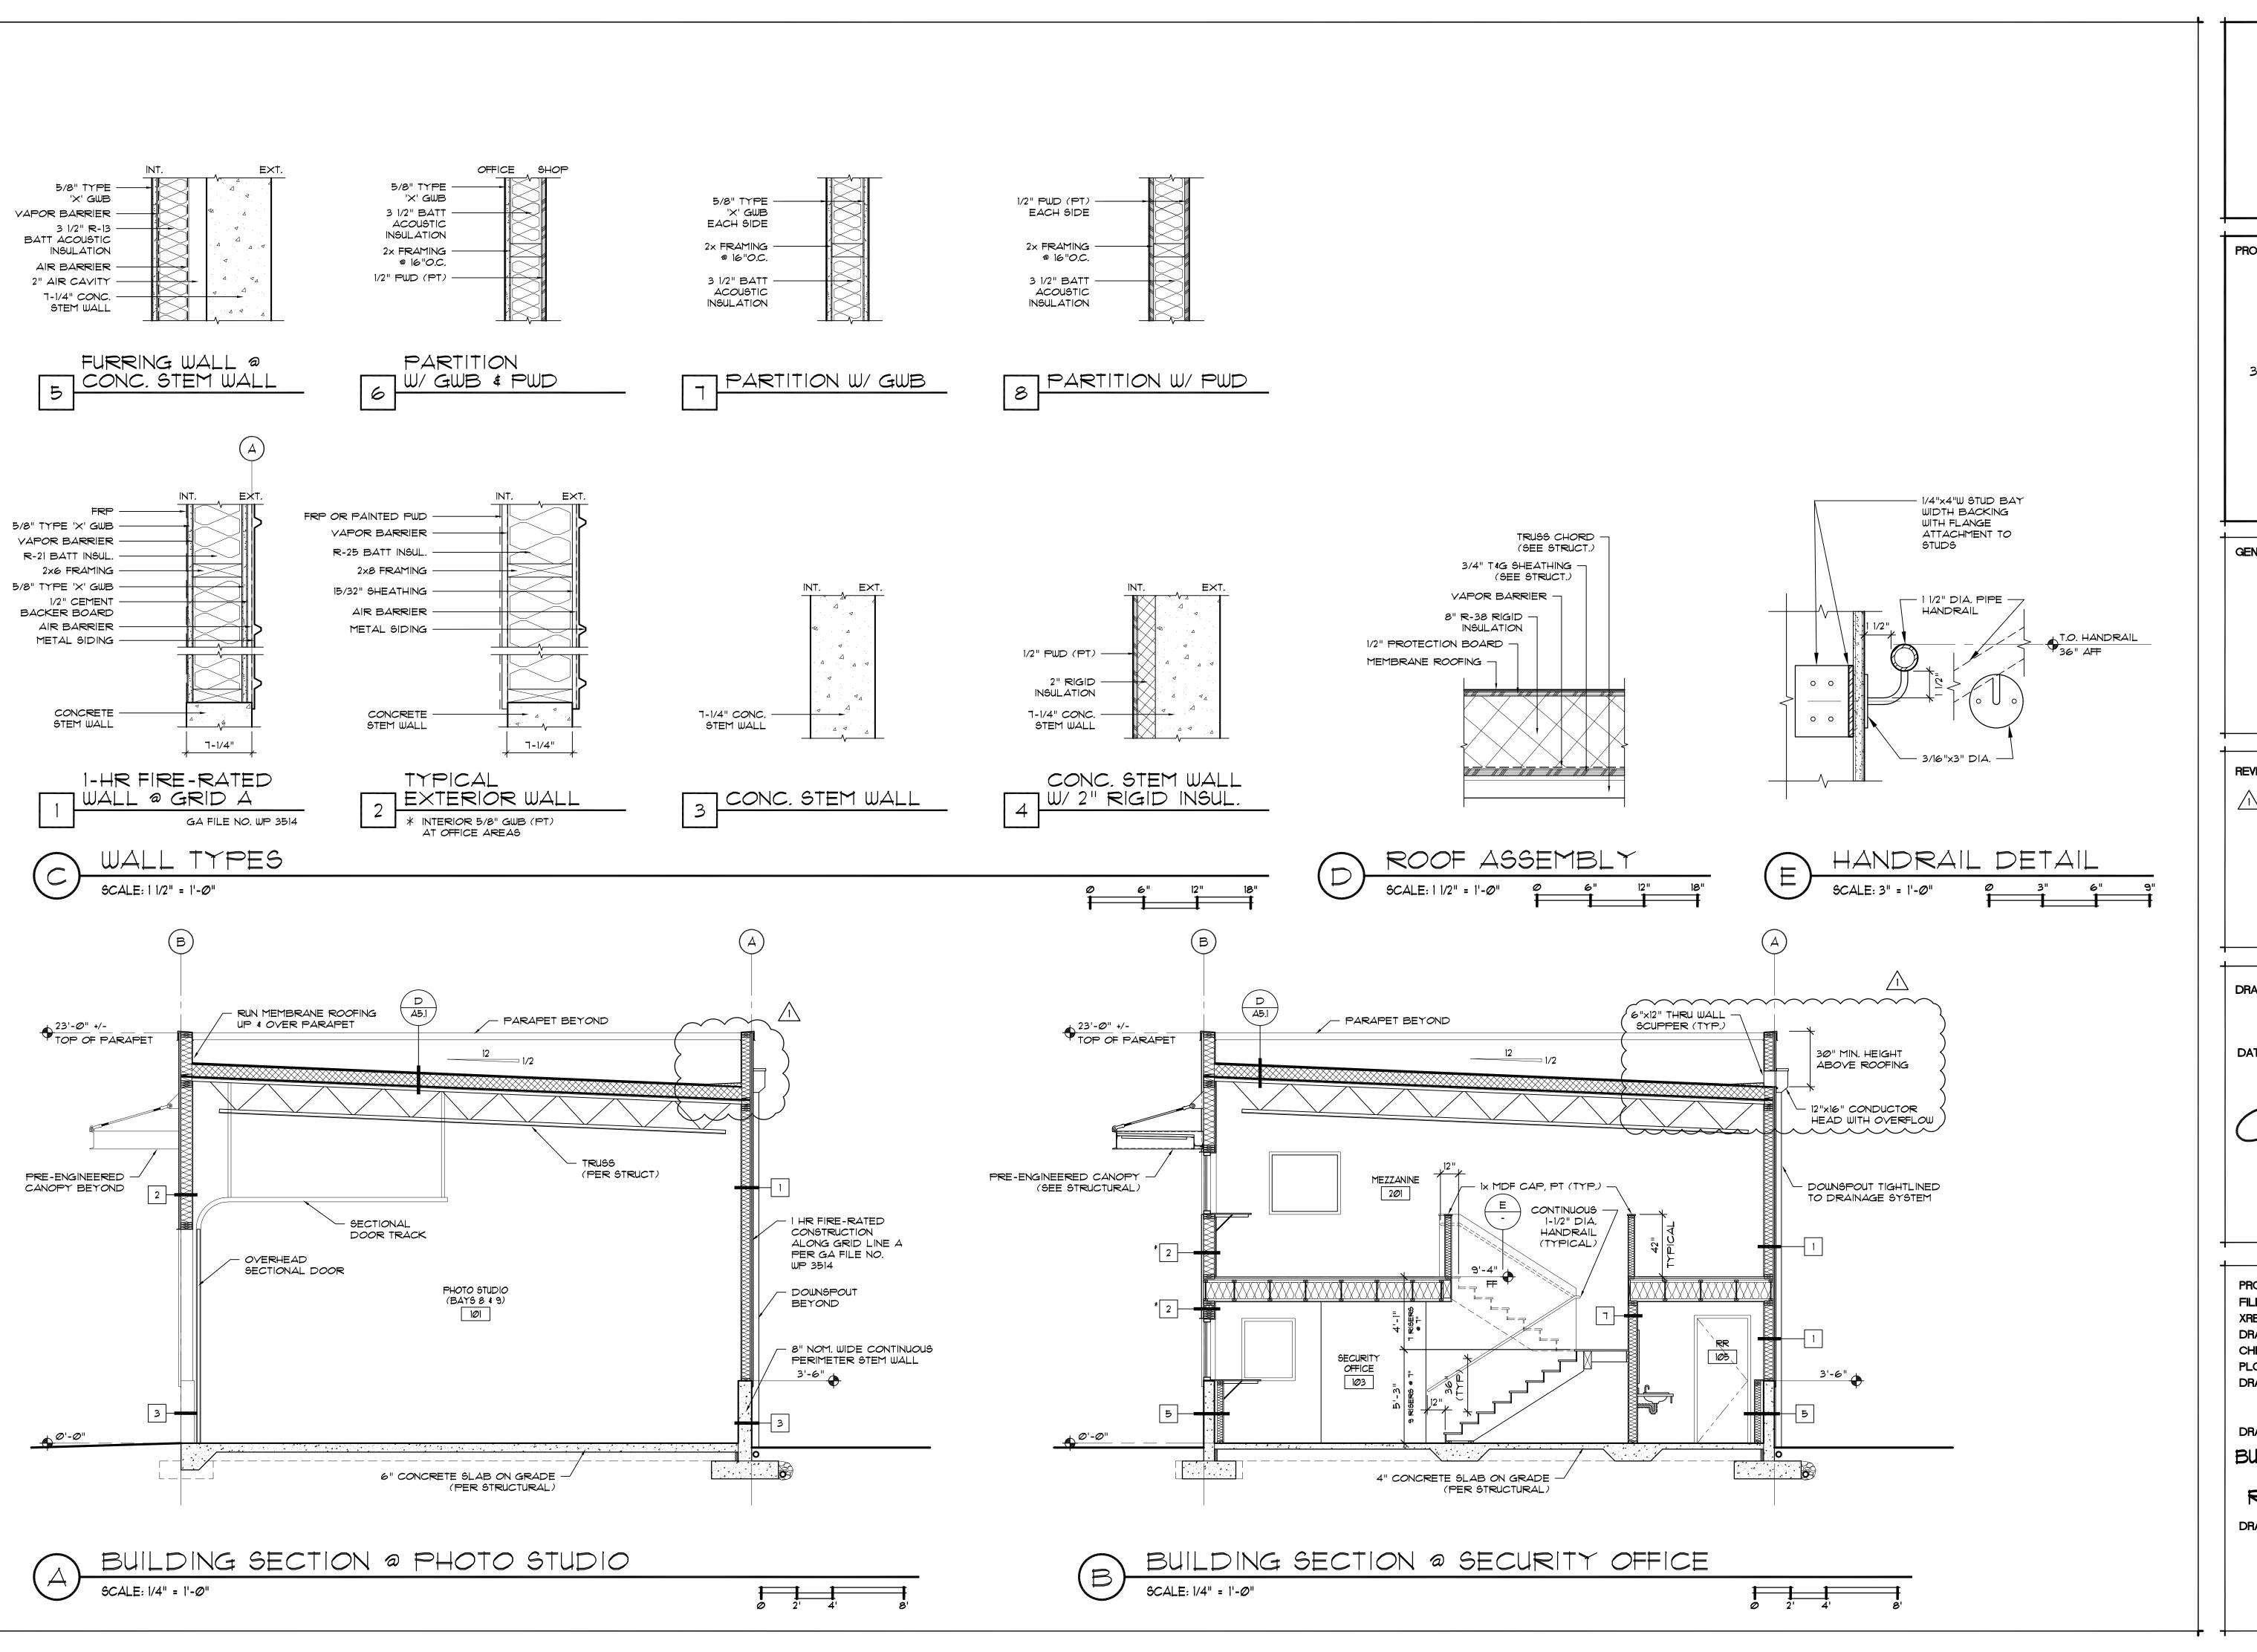DRAWING NO.:

A5.1

DOOR NO.	OPENING SIZE WIDTH X HEIGHT X THICKNESS	DOOR TYPE MATERIAL FINISH			FRAME TYPE MATERIAL FINISH			FIRE ASSEMBLY RATING	HDRW SET NO	REMARKS
					_ · · · · _			ZATING		
1014	6'-0" × 7'-0" × 1-3/4"	1	ALUM	-	Д	ALUM	_	-	1	-
101B	14'-0" × 12'-0"	5	ALUM	-	-	-	-	-	5	CONFIRM OPERATOR
1 <i>0</i> 2 <i>A</i>	3'-0" × 7'-0" × 1-3/4"	2	HM/INSUL	PT	В	HM/INSUL	PT	-	2	-
1Ø2B	3'-0" × 7'-0" × 1-3/4"	2	HM/INSUL	PT	В	HM/INSUL	PT	-	3	-
103	3'-0" × 7'-0" × 1-3/4"	2	HM/INSUL	PT	В	HM/INSUL	PT	-	3	-
104	3'-0" × 7'-0" × 1-3/4"	3	HM/INSUL	PT	В	HM	PT	-	4	-
105	3'-0" × 7'-0" × 1-3/4"	3	HM/INSUL	PT	В	HM/INSUL	PT	-	4	-
106	10'-0" × 12'-0"	4	ALUM	-	-	-	-	-	6	CONFIRM OPERATOR
107	10'-0" × 12'-0"	4	ALUM	-	-	-	-	-	6	CONFIRM OPERATOR
108	10'-0" × 12'-0"	4	ALUM	-	-	-	-	-	6	CONFIRM OPERATOR
109	10'-0" × 12'-0"	4	ALUM	-	-	-	-	-	6	CONFIRM OPERATOR
110	10'-0" × 12'-0"	4	ALUM	-	-	-	-	-	6	CONFIRM OPERATOR
111	10'-0" × 12'-0"	4	ALUM	-	-	-	-	-	6	CONFIRM OPERATOR
112	10'-0" × 12'-0"	4	ALUM	-	-	-	-	-	6	CONFIRM OPERATOR
1144	10'-0" × 12'-0"	4	ALUM	-	-	-	-	-	6	CONFIRM OPERATOR
1148	10'-0" × 12'-0"	4	ALUM	-	-	-	-	-	6	CONFIRM OPERATOR
-	-	-	-	-	-	-	-	-	-	-
-	-	_	-	_	_	-	_	_	-	-

ABBREVIATIONS

FACTORY FINISH

HOLLOW METAL

MANUFACTURER

STAINLESS STEEL

PLEXIGLASS

INSULATED

MINUTE

PAINT

PRE-FIN PRE-FINISHED

STEEL

STAIN

YYL YINYL

TEMPERED

TBD TO BE DETERMINED

PG

STL

STN

DOOR SCHEDULE NOTES

BE EXPOSED AND USABLE FROM BOTH SIDES.

DIMENSIONS ARE NOMINAL, FIELD VERIFY ALL DIMENSIONS. ALUM ALUMINUM EXIST EXISTING

PROVIDE TEMPERED GLAZING WHERE REQUIRED PER CONSUMER PRODUCT SAFETY COUNCIL AND THE IBC. HARDWARE TO COMPLY WITH 2018 IBC AND ANSI AII7.1-2009 REQUIREMENTS.

A. DOOR THRESHOLDS TO BE 1/2" CHANGE IN ELEXATION MAXIMUM AT NO MORE THAN 1:2 BEVELY

5. ALL EGRESS DOORS ARE TO BE READILY OPENABLE FROM THE EGRESS SIDE WITHOUT THE USE OF A KEY

OR SPECIAL KNOWLEDGE OR EFFORT. YE! PER ICCIANS AIM 1-2009 SECTION 4042 & BOOR HARDWARE. HANDLES, PULLS, LATCHES, LOCKS, AND OTHER OPERABLE PARTS ON ACCESSIBLE DOORS SHALL HAVE A SHAPE THAT IS EASY TO GRASP WITH ONE HAND AND DOES NOT REQUIRE TIGHT GRASPING, PINCHING, OR TWISTING OF THE WRIST TO OPERATE. OPERABLE PARTS OF SUCH HARDWARE SHALL BE 34 INCHES (865 MM) MINIMUM AND 48 INCHES (1220 MM) MAXIMUM ABOVE THE FLOOR. WHERE SLIDING DOORS ARE IN THE FULLY OPEN POSITION, OPERATING HARDWARE SHALL

T. THE FORCE REQUIRED TO OPEN A DOOR SHALL NOT EXCEED 8.5 POUNDS AT EXTERIOR DOORS AND 5

POUNDS AT INTERIOR DOORS.

HARDWARE SETS

HW 1 (ENTRY DOUBLE DOORS) (ALL HARDWARE BY DOOR MANUFACTURER)

- 6 EA HINGES 2 EA CLOSERS
- 2 SET PUSH/PULL 1 SET FLUSHBOLTS
- 1 EA DEADBOLT 2 EA KICKDOWN STOPS (INTERNAL SIDE)
- 1 SET WEATHERSTRIPPING I EA ADA THRESHOLD
- SIGN "THIS DOOR TO REMAIN UNLOCKED DURING BUSINESS HOURS"

HW 2 (ENTRY DOOR) 3 EA HINGES

- 1 EA CLOSER
- 1 EA LOCKSET (CLASSROOM TYPE)
- I EA FLOOR STOP 1 EA KICKPLATE (INTERIOR SIDE)
- I EA ADA THRESHOLD 1 SET WEATHERSTRIPPING


HW 3 (VESTIBULE)

- 3 EA HINGES 1 EA LOCKSET (CLASSROOM TYPE)
- 2 EA KICKPLATES
- 1 EA WALL STOP 1 EA ADA THRESHOLD 1 SET WEATHERSTRIPPING

- HW 4 (RESTROOMS) 3 EA HINGES 1 EA CLOSER
- 1 EA LOCKSET (PRIVACY TYPE W/ INDICATOR) 2 EA KICKPLATES
- 1 EA WALL STOP
- 3 EA SILENCERS

HW 5 (OVERHEAD DOOR 101B) (ALL HARDWARE BY DOOR MANUFACTURER)

HW 6 (TYPICAL OVERHEAD DOOR) (ALL HARDWARE BY DOOR MANUFACTURER)

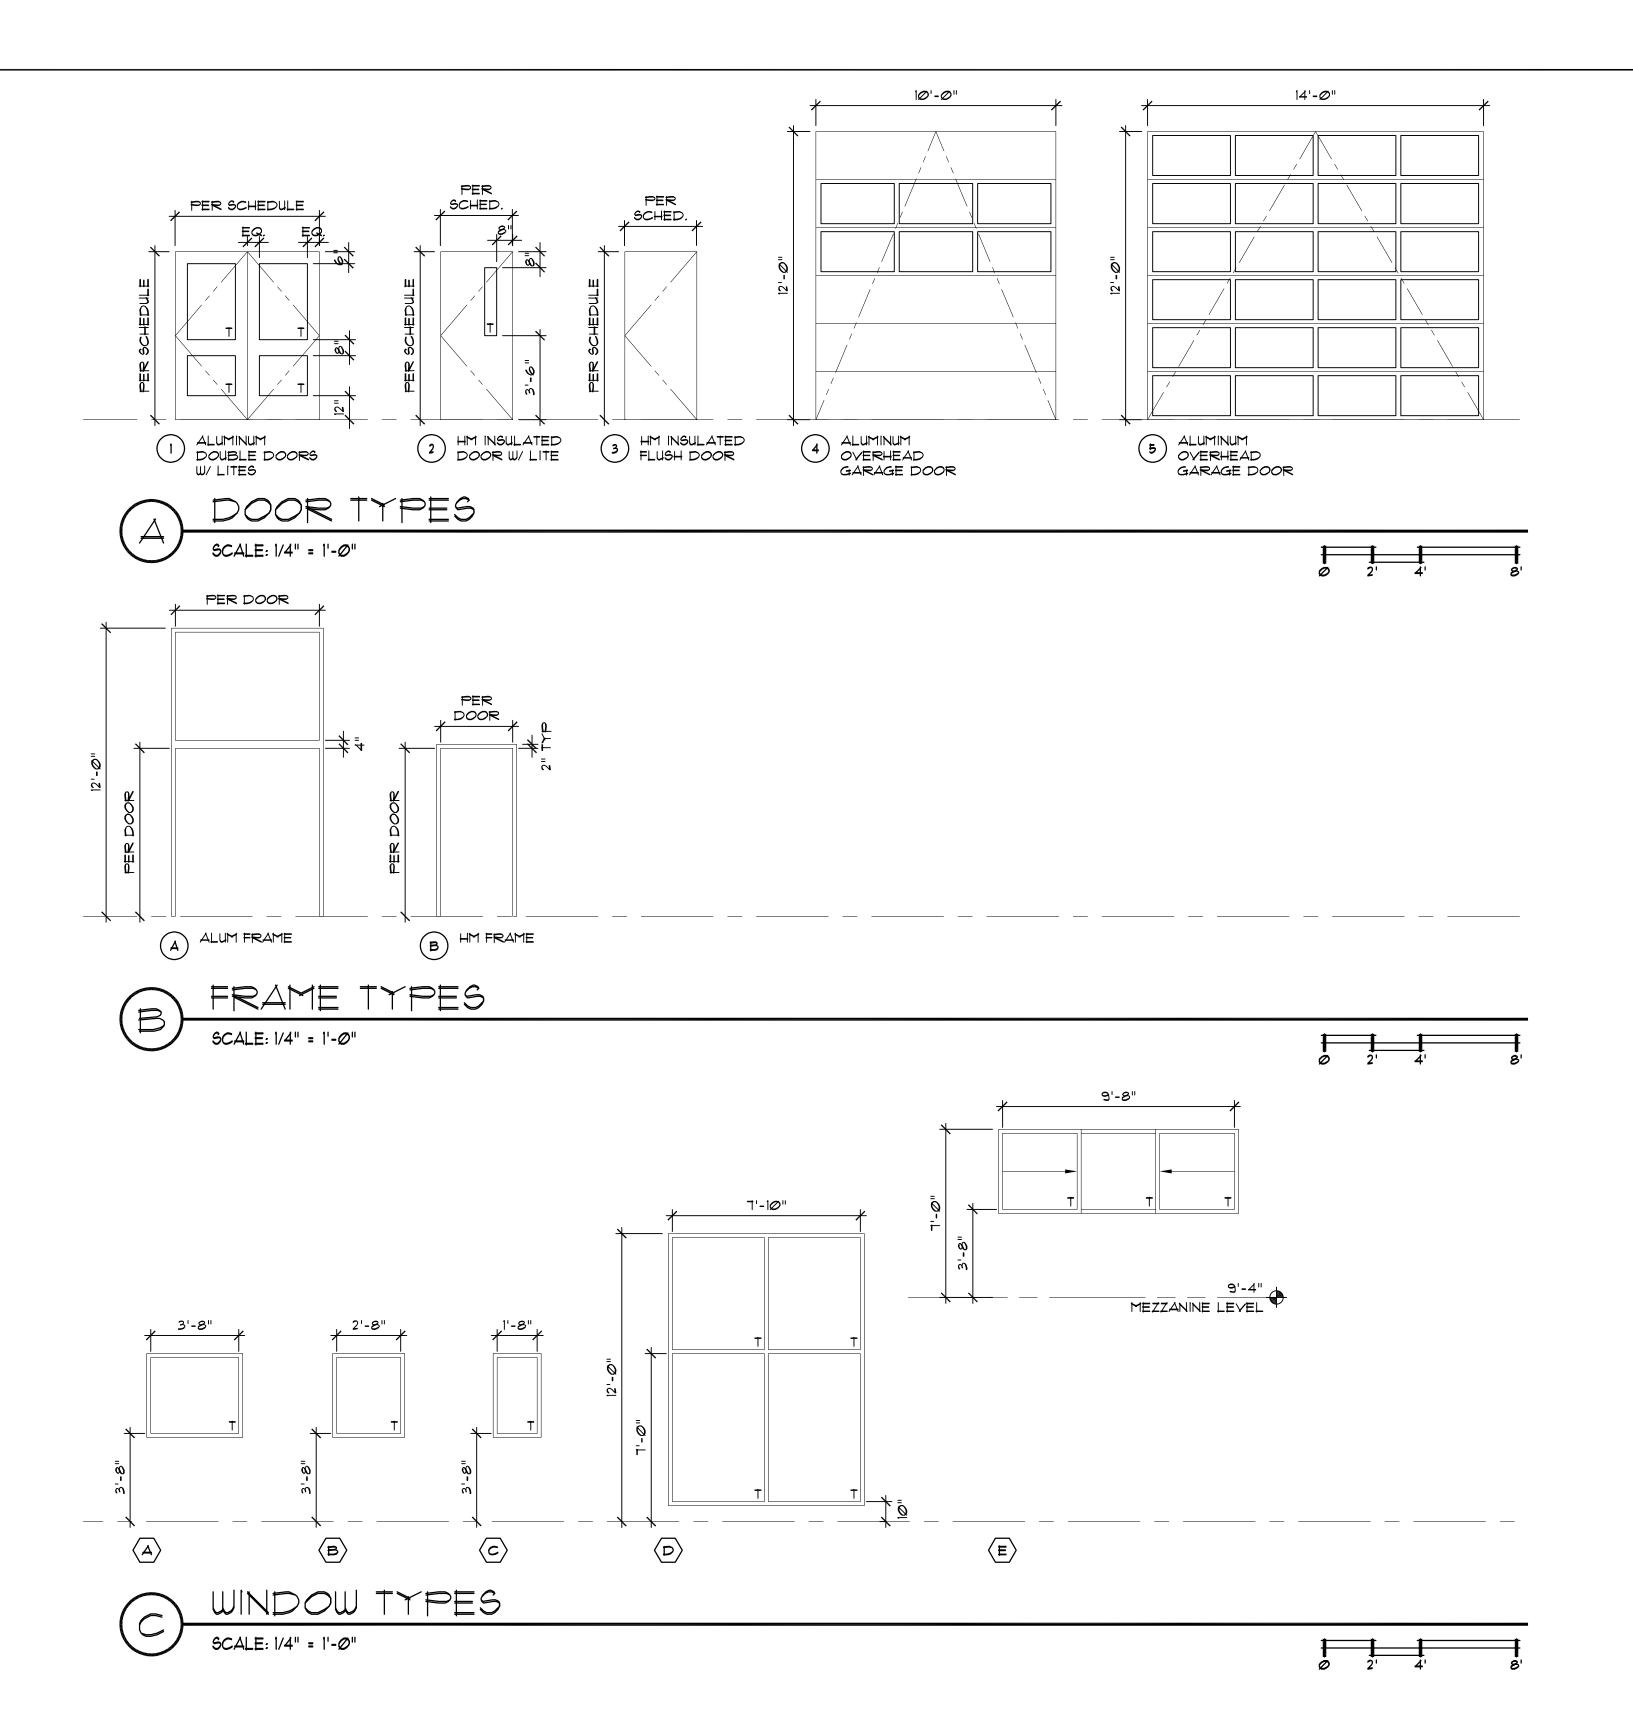

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GENERAL NOTES:

REVISIONS:

C.O.T. COMMENT RESPONSE 10.03.2023

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PROJECT NO.: 22*0*2*.00* FILE NAME: XREFS: DRAWN BY: ΜZ DB CHECKED BY:


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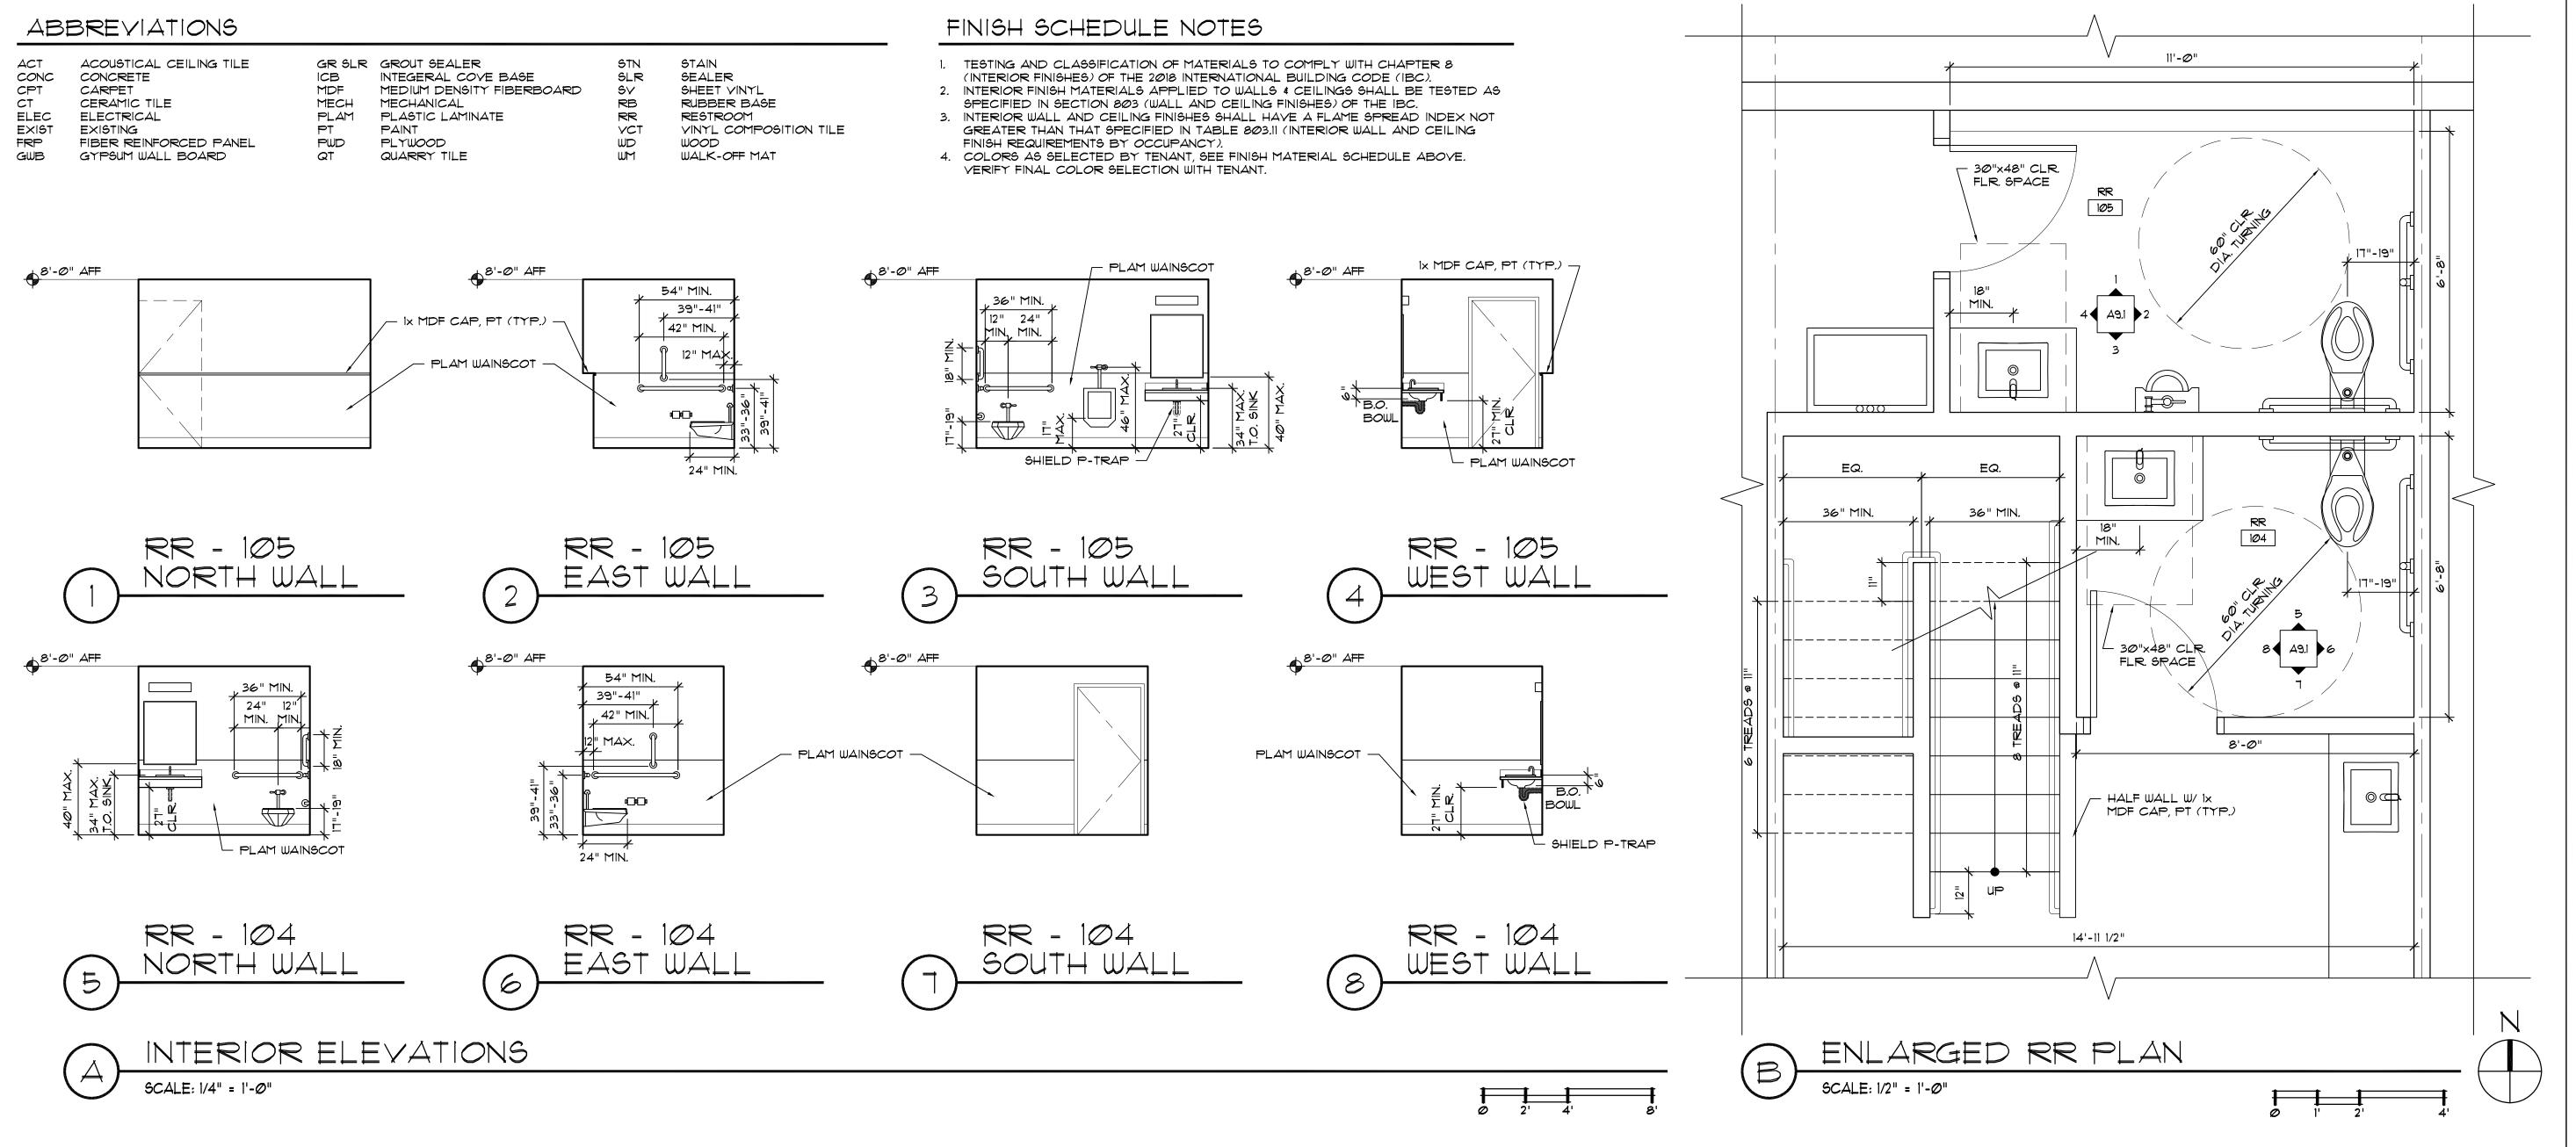
DRAWING CONTENTS:

PLOT SCALE:

DOOR SCHEDULE, DOOR TYPES \$ WINDOW TYPES

DRAWING NO.:



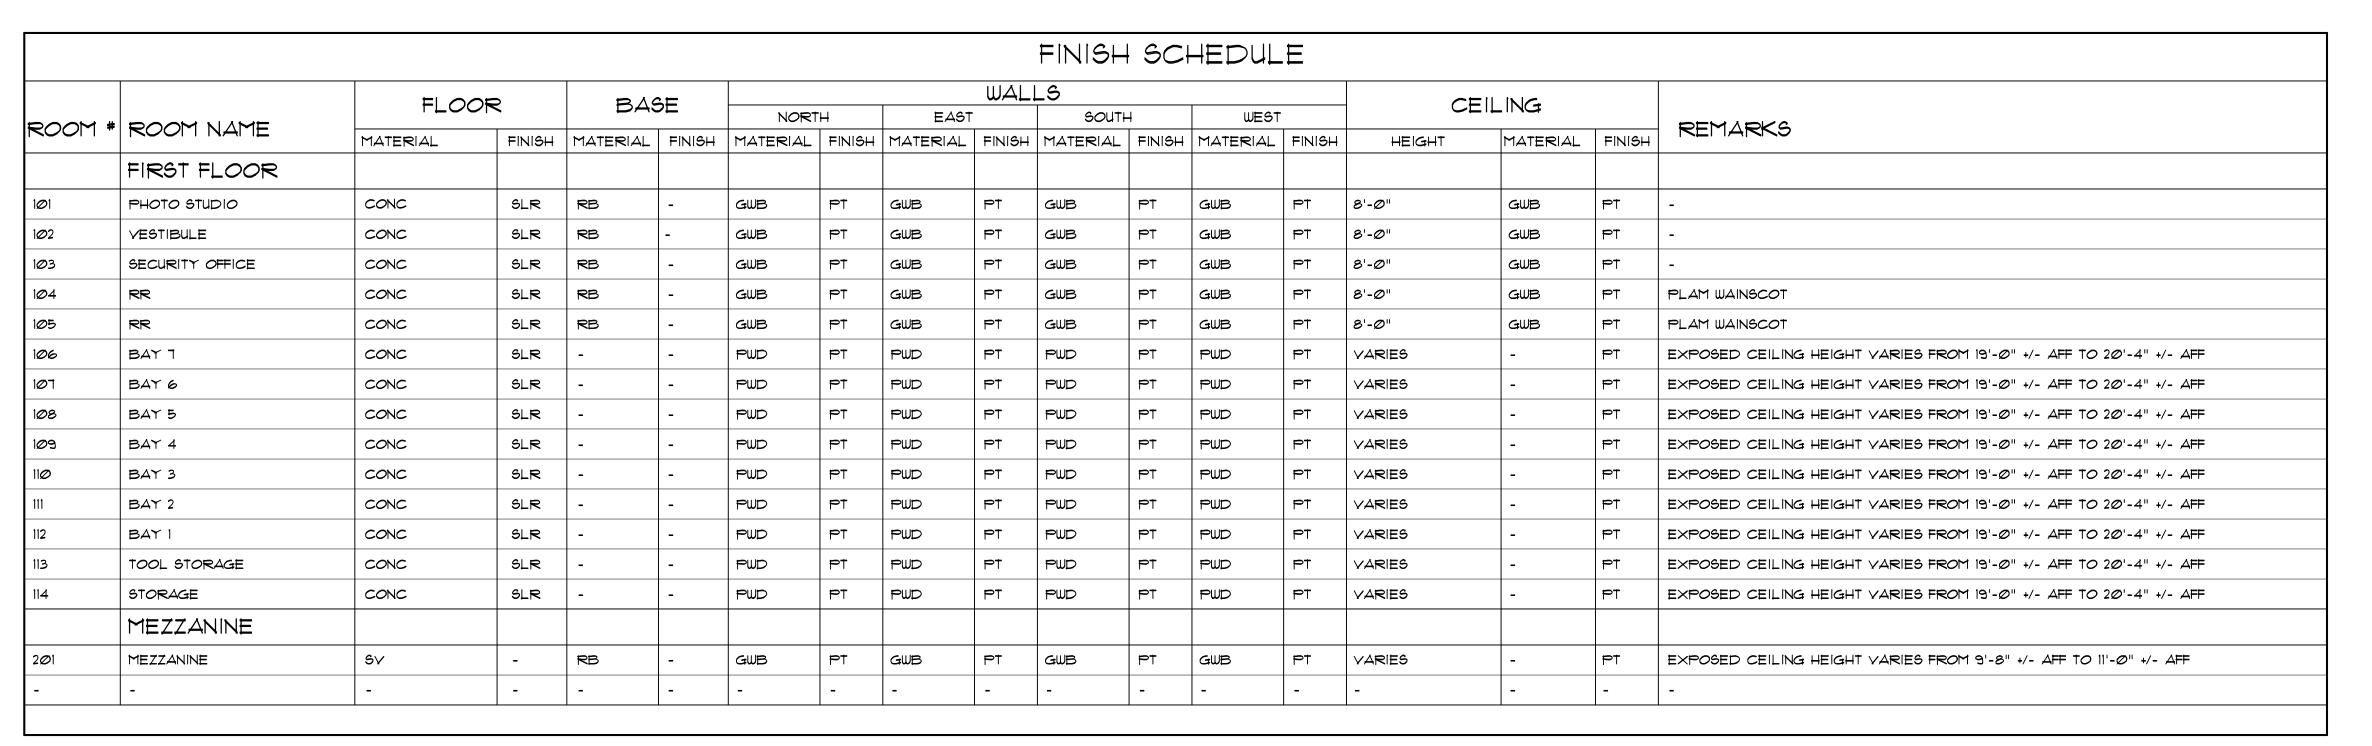

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PROJECT NO: 2202.00
FILE NAME:
XREFS:
DRAWN BY: MZ
CHECKED BY: DB

PLOT SCALE: 1:1

DRAWING SCALES: AS NOTED

DRAWING CONTENTS:

FINISH SCHEDULE, INT. ELEVATIONS & ENLARGED PLANS

DRAWING NO.:

A9.1